



REPLY TO
ATTENTION OF

DEPARTMENT OF THE ARMY
CORPS OF ENGINEERS, NEW ORLEANS DISTRICT
7400 LEAKE AVENUE
NEW ORLEANS, LOUISIANA 70118

Operations Division
Regulatory Branch

AUG 8 2017

SUBJECT: MVK-2000-01263

City of Monroe
c/o Louisiana Department of Transportation and Development
Post Office Box 94245
Baton Rouge, Louisiana 70804

Gentlemen:

As requested in your correspondence on March 20, 2017, the authorization granted by the Secretary of the Army in permit referenced above, dated January 25, 2012, from the District Engineer at Vicksburg, Mississippi, to construct the Kansas Lane Connector from Desiard Street to US 165 in Monroe, Ouachita Parish, Louisiana, is specifically extended to August 31, 2020.

The conditions, to which the work is made subject, excepting the time limit for completion, remain in full force and effect.

If the work authorized is not completed on or before the date herein specified, this authorization, if not previously revoked or specifically further extended, will cease and become null and void.

A copy of this permit approval letter must be conspicuously displayed at the project site. Also, you must keep a copy of this signed letter, with attached drawings, at the project site until the work is completed.

This is the last extension of time, which will be granted for this permit without full permit reprocessing. If the work is not completed by the date granted under this letter, it will be necessary for you to reapply for a permit to perform any work after that date. You then must submit a new completed application form, permit drawings indicating work completed and remaining, and request new letters of no objection. It is possible that, as a result of the new evaluation, your request for a time extension could be denied or the authorization for the portion of your project not completed could be significantly modified.

BY AUTHORITY OF THE SECRETARY OF THE ARMY:

Martin Mayer
Chief, Regulatory Branch
for
Michael N. Clancy
Colonel, U.S. Army
District Commander

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328	HS-03 04-07-14
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331 - 334	MC-01 (4 SHTS.) 04-16-12
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(5 SHTS.)	
340	R-CB-11 03-01-11
341	R-CB-11 MOD. 03-01-11
342	RM-01 06-03-09
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06-07,09-10,16,19 (14 SHTS.)	
357	WP-01 12-23-13
401 - 552	CROSS SECTIONS
TOTAL SHEETS = 518	

KANSAS LANE	U.S. HWY. 80	U.S. HWY. 165	OLD STERLING ROAD
ROADWAY CLASS: UA-2	ROADWAY CLASS: UA-2	ROADWAY CLASS: UA-3	ROADWAY CLASS: UC-2
TRAFFIC DATA	TRAFFIC DATA	TRAFFIC DATA	TRAFFIC DATA
2015 A.D.T. = N/A	2015 A.D.T. = 32,135	2015 A.D.T. = 39,953	2015 A.D.T. = 4,430
2035 A.D.T. = 27,300	2035 A.D.T. = 35,790	2035 A.D.T. = 50,730	2035 A.D.T. = 11,060
D = 54%	D = 53%	D = 52%	D = 55%
K = 10%	K = 10%	K = 10%	K = 10%
T = 6%	T = 7%	T = 21%	T = 3%
DESIGN SPEED = 45 M.P.H.	DESIGN SPEED = 40 M.P.H.	DESIGN SPEED = 50 M.P.H.	DESIGN SPEED = 45 M.P.H.

DATE	REVISION	DATE RECOMMENDED	DATE APPROVED


SCHEDULE OF REVISIONS

TYPE OF CONSTRUCTION:

GRADING, EARTHWORK, DRAINAGE STRUCTURES, BASE COURSE, ASPHALTIC CONCRETE PAVEMENT, PORTLAND CEMENT CONCRETE PAVEMENT AND BRIDGE


STATE OF LOUISIANA
DEPARTMENT OF TRANSPORTATION AND DEVELOPMENT
PLANS OF PROPOSED STATE HIGHWAY

STATE PROJECT NO. H.007289
F.A.P. NO. H007289
KANSAS LANE EXTENSION

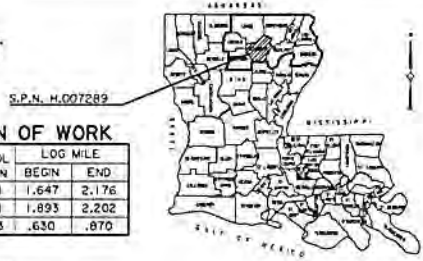

LOCATION OF WORK

ROUTE NO.	CONTROL SECTION	BEGN LOG MILE	END LOG MILE
US 80	002-01	1.647	2.176
US 165	016-01	1.893	2.202
LA 840-G	B37-23	.630	.870

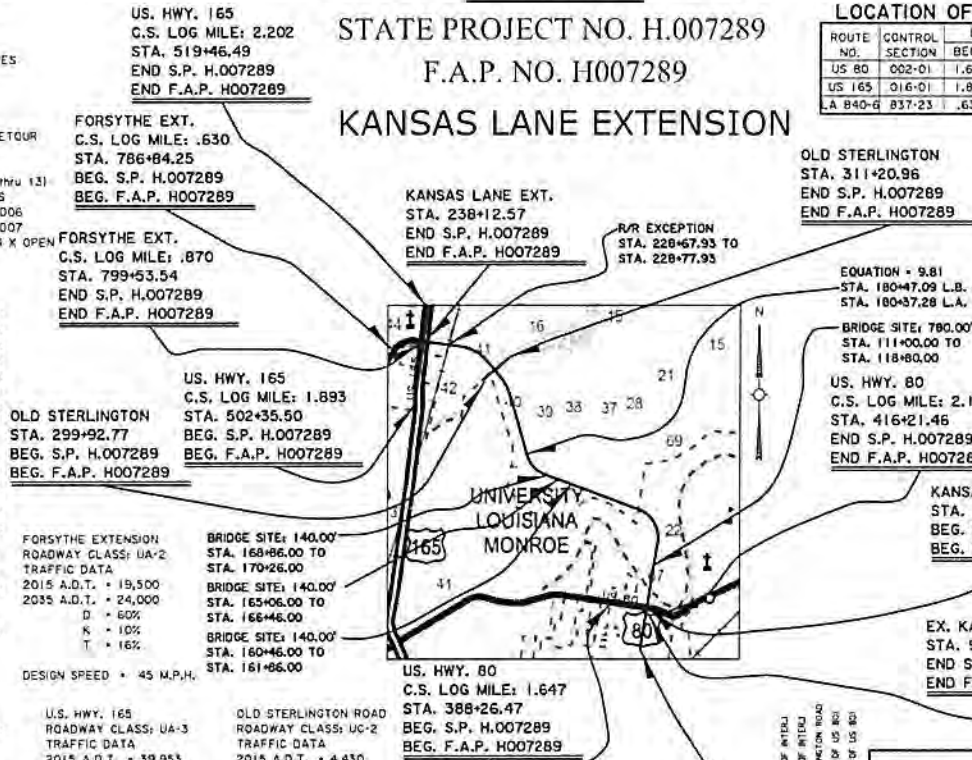

VICINITY MAP PERMIT SKETCHES

PRELIMINARY FOR PERMITTING PURPOSES ONLY

Louisiana Department of Transportation and Development

UNIVERSITY LOUISIANA MONROE

18247 - 2024

DATE: 4/18/2017

Preliminary Plans
Subject to Change
Road Design

APPROVED

DENSON ENGINEERING, INC.
DATE _____


CITY OF MONROE
DATE _____

DOTD CHIEF ENGINEER
DATE _____

LENGTH OF PROJECT

DESCRIPTION	ALGEBRAIC SUM OF ALL EQUATIONS	GROSS LENGTH	EXCEPTION	BRIDGE LENGTH	ROADWAY LENGTH
STATION TO STATION	FEET	FEET	FEET	FEET	FEET
85+90.04 - 89+54.00	1,343.96				1,343.96
100+22.01 - 79+12.57	9.81	15,790.37	10.00	1,200	12,590.37
299+92.77 - 311+20.96	1,128.19				1,128.19
502+15.50 - 507+21.96	486.46				486.46
508+01.35 - 518+48.49	1,145.14				1,145.14
288+26.47 - 416+21.46	2,794.99				2,794.99
786+84.25 - 799+53.54	1,269.29				1,269.29
7-88.43 - 8+73.00	174.57				174.57
10-36.89 - 12-35.00	198.11				198.11
10-51.00 - 12+48.74	217.74				217.74
5+78.18 - 9+48.00	369.82				369.82
10+15.80 - 12-31.36	215.56				215.56
TOTAL LENGTH OF BRIDGES			1,200	0.227	
TOTAL LENGTH OF ROADWAY					21,974.52
TOTAL MILES					4.385

LAYOUT MAP

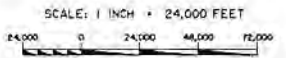

DATUM USED: HOR. NAD 83, VERT. NVD 88
MAGNETIC VAR: _____
BEARINGS ARE: GRID

TRANSIT BOOKS: LA INC. 162 & 167
LEVEL BOOKS: _____

SCALES:

PLAN - 1"=20'
PROFILE HOR. - 1"=20'
VERT. - 1"=5'

NOTE:

THE 2006 EDITION OF THE LOUISIANA DOTD STANDARD SPECIFICATIONS FOR ROADS AND BRIDGES, AS AMENDED BY THE PROJECT SPECIFICATIONS, SHALL GOVERN ON THIS PROJECT.

PERMIT SKETCHES

TITLE SHEET

KANSAS LANE EXTENSION

SHEET NO. 1

PROJECT NO. H.007289

DATE: 4/18/2017

DRAWN BY: [Signature]

CHECKED BY: [Signature]

IN CHARGE: [Signature]

SCALE: AS SHOWN

WETLAND DELINEATION SITE SUMMARY TABLE

State Project No. 700-37-0110

Federal Aid Project No. HP-T021(018)

Kansas Lane


Monroe, Ouachita Parish, Louisiana

Sites 1 - 7



Site	Station		Total Impacts (Acres)		Type
	Start	End	Wetlands	Other Waters	
1	110+80	118+20	--	0.813 (B)	BD, PS
2	149+75	175+40	7.806	--	BLH
3	180+00	192+65	3.350	--	BLH
4	206+70	206+76	--	0.020 (C)	IS
5	209+00	210+50	0.108	--	BLH
6	211+50	228+20	3.956	0.046 (C)	BLH, HW, IS
7	228+95	229+05	0.02	--	BLH
Totals			15.24	0.899	

Legend: BLH – Bottomland Hardwood; BD – Bayou Desiard;
PS – Perennial Stream; IS – Intermittent Stream;
HW- Herbaceous Wetland; (C) – Culvert; (B) – Bridge

PERMIT SKETCHES

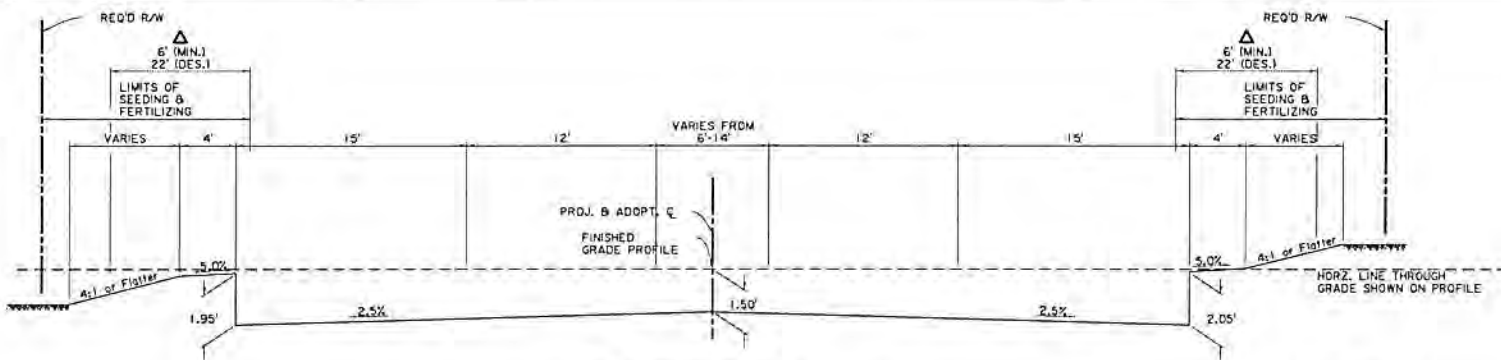


TYPICAL GRADING SECTION (N.T.S.)
 APPLIES STA. 228+04.24 TO STA. 228+67.93
 APPLIES STA. 228+77.93 TO STA. 230+23.92

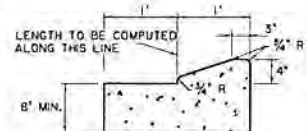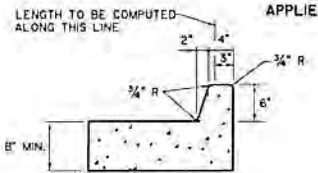

PERMIT SKETCHES

PRELIMINARY	Louisiana Department of Transportation and Development
FOR PERMITTING PURPOSES ONLY	APPROVED: THOMAS W. ROBERTS LICENSE NO. 10357 DATE: 02/04/2012

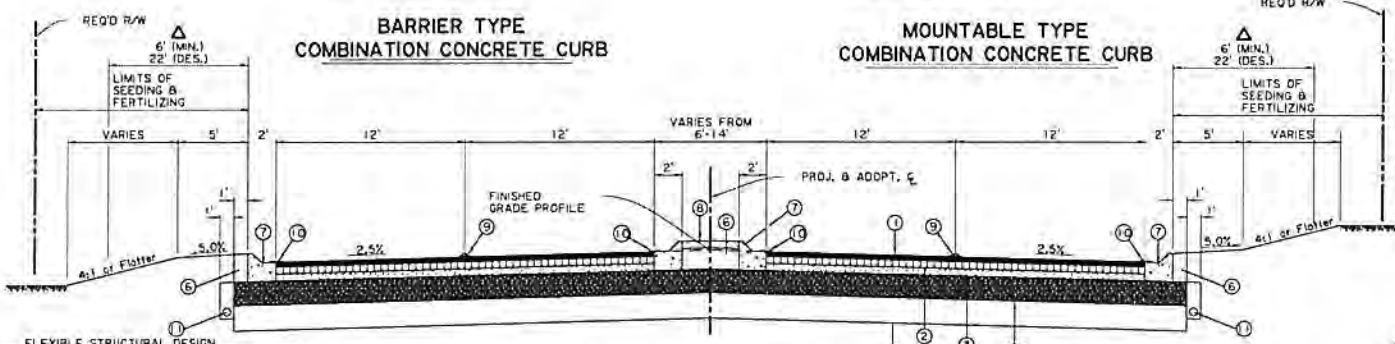

TYPICAL FINISHED SECTION (N.T.S.)
 APPLIES STA. 228+04.24 TO STA. 228+67.93
 APPLIES STA. 228+77.93 TO STA. 230+23.92

FLEXIBLE STRUCTURAL DESIGN

CURRENT ADT	• N/A
MEDIUM ADT	• N/A
DESIGN ADT	• 27,500
PERFORMANCE PERIOD (YEARS)	• 20
18 Kip ESALS	• 1,120.24
ESALS OVER DESIGN LIFE (W18)	• 8,177,760.03
SOIL RESILIENT MODULUS (PSI)	• 10,000
STRUCTURAL NO. REQUIRED (INCHES)	• 4.6
STRUCTURAL NO. PROVIDED (INCHES PER LAYER)	
1 - WEARING COURSE, SUPERPAVE	• 0.88
2 - BINDER COURSE, SUPERPAVE	• 1.32
3 - BASE COURSE, SUPERPAVE	• 0.99
4 - BASE COURSE, IN-PLACE CEMENT TREATED	• 1.40
STRUCTURAL NO. PROVIDED (TOTAL INCHES)	• 4.59

NOTE:
 FOR STA. 228+33 - 229+12,
 SEE SH. 679 FOR GRAPHICAL GRADES.

- LEGEND**
- ① 2 IN. SUPERPAVE ASPHALTIC CONCRETE WEARING COURSE, LEVEL 1F
 - ② 3 IN. SUPERPAVE ASPHALTIC CONCRETE BINDER COURSE, LEVEL 1
 - ③ 3 IN. SUPERPAVE ASPHALTIC CONCRETE BASE COURSE, LEVEL 1
 - ④ 10 IN. CLASS II BASE COURSE (STONE OR RECYCLED P.C.C.)
 - ⑤ 12 IN. SUBGRADE LAYER (TREATED) USE AS DIRECTED BY PROJ. ENG.
 - ⑥ EMBANKMENT
 - ⑦ COMBINATION CURB & DUTTER (MOUNTABLE)
 - ⑧ 6 IN. INCIDENTAL CONCRETE (W/RED PIGMENT)
 - ⑨ PAVEMENT STRIPING & REFLECTORIZED MARKERS
 - ⑩ PAVEMENT STRIPING
 - ⑪ 4" PERFORATED PIPE UNDERDRAIN (TO BE TIED INTO SUBSURFACE DRAINAGE SYSTEM)

△ TO BE CONSTRUCTED FREE OF OBSTRUCTIONS

Preliminary Plans
 Subject to Change
 Road Design


SHEET NUMBER	28
PROJECT NUMBER	DUACHITA
DATE	11/16
SCALE	N.007289
DESIGNED BY	MB
CHECKED BY	MB
DATE	11/16
SCALE	AS SHOWN

KANSAS LANE EXTENSION
 ASPHALTIC CONCRETE PAVEMENT
 WITH 6" RAISED MEDIAN
 TYPICAL SECTION


PERMIT SKETCHES
 210+25.00 TO 213+10.00
 11/17/16
 H-007289

PERMIT SKETCHES

PRELIMINARY FOR PERMITTING PURPOSES ONLY	Louisiana Department of Transportation and Development ENGINEER: THOMAS M. ADAMS LICENSE NO. 19481 DATE: 11/20/17
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TYPICAL GRADING SECTION (N.T.S.)
APPLIES STA. 210+25.00 TO STA. 213+10.00

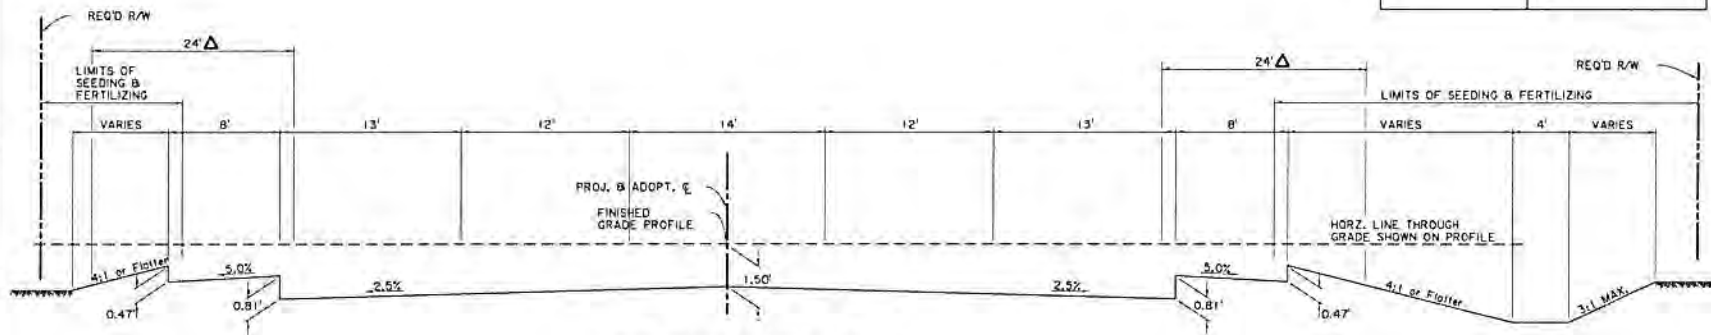

TYPICAL FINISHED SECTION (N.T.S.)
APPLIES STA. 210+25.00 TO STA. 213+10.00

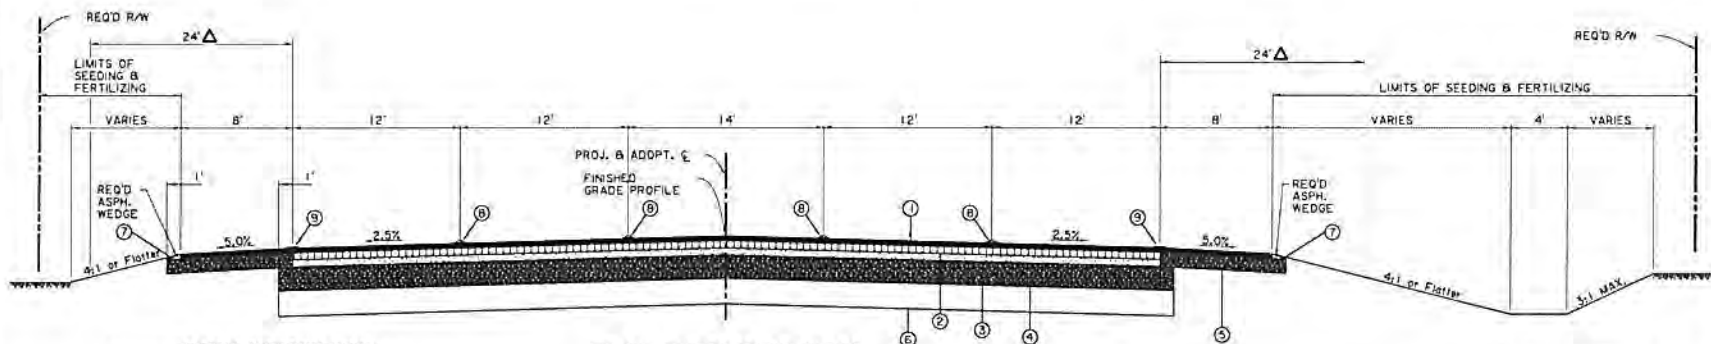
FLEXIBLE STRUCTURAL DESIGN

CURRENT ADT	* N/A
MEDIUM ADT	* N/A
DESIGN ADT	* 27,300
PERFORMANCE PERIOD (YEARS)	* 20
18 Kip ESALS	* 1,120.24
ESALS OVER DESIGN LIFE (W18)	* 8,177,760.03
SOIL RESILIENT MODULUS (PSI)	* 10,000
STRUCTURAL NO. REQUIRED (INCHES)	* 4.6
STRUCTURAL NO. PROVIDED (INCHES PER LAYER)	
1 - WEARING COURSE, SUPERPAVE	* 0.88
2 - BINDER COURSE, SUPERPAVE	* 1.32
3 - BASE COURSE, SUPERPAVE	* 0.99
4 - BASE COURSE, IN-PLACE CEMENT TREATED	* 1.40
STRUCTURAL NO. PROVIDED (TOTAL INCHES)	* 4.59

- LEGEND
- ① 2 IN. SUPERPAVE ASPHALTIC CONCRETE WEARING COURSE, LEVEL 1F
 - ② 3 IN. SUPERPAVE ASPHALTIC CONCRETE BINDER COURSE, LEVEL I
 - ③ 3 IN. SUPERPAVE ASPHALTIC CONCRETE BASE COURSE, LEVEL I
 - ④ 10 IN. CLASS II BASE COURSE (STONE OR RECYCLED P.C.C.)
 - ⑤ 8 IN. CLASS II BASE COURSE (STONE OR RECYCLED P.C.C.)
 - ⑥ 12 IN. SUBGRADE LAYER (TREATED) (USE AS DIRECTED BY PROJ. ENG.)
 - ⑦ EMBANKMENT
 - ⑧ PAVEMENT STRIPING & REFLECTORIZED MARKERS
 - ⑨ PAVEMENT STRIPING
- △ TO BE CONSTRUCTED FREE OF OBSTRUCTIONS

Preliminary Plans
 Subject to Change
 Road Design

SHEET	21	DATE	11/17/16	PROJECT	H-007289
DESIGNED	TMB	CHECKED	TMB	IN CHARGE	TMB
DRAWN	TMB	APPROVED	TMB	SCALE	AS SHOWN
TYPICAL SECTION ASPHALTIC CONCRETE PAVEMENT KANSAS LANE EXTENSION					

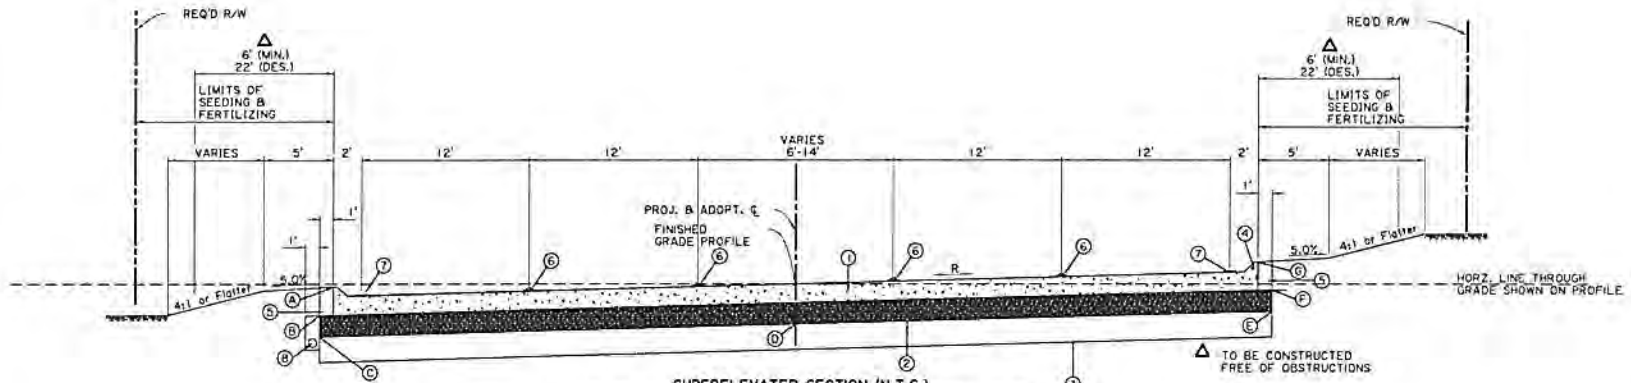

SUPERELEVATED SECTION (N.T.S.)
 APPLIES STA. 121+00.00 TO STA. 122+48.32 (SUPER 3.7%)
 APPLIES STA. 125+93.71 TO STA. 134+60.18 (SUPER 3.7%)


LEGEND

- ① 10 IN. PORTLAND CEMENT CONCRETE PAVEMENT
- ② 10 IN. CLASS II BASE COURSE (STONE OR RECYCLED P.C.C.)
- ③ 12 IN. SUBGRADE LAYER (TREATED) (USE AS DIRECTED BY PROJ. ENG.)
- ④ INTEGRAL CONCRETE CURB (MOUNTABLE)/BARRIER IN TURNOUTS
- ⑤ EMBANKMENT
- ⑥ PAVEMENT STRIPING & REFLECTORIZED MARKERS
- ⑦ PAVEMENT STRIPING
- ⑧ 4" PERFORATED PIPE UNDERDRAIN (TO BE TIED INTO SUBSURFACE DRAINAGE SYSTEM)

SUPERELEVATION DETAILS (IN FEET) WITH REFERENCE TO HORIZONTAL LINE THROUGH GRADE SHOWN ON PROFILE

RADIUS	R	A	B	C	D	E	F	G	TRANSITION LENGTH
∞	NC	-0.43	-1.58	-2.42	-1.67	-2.42	-1.58	-0.43	NA
1000'	3.70%	-0.90	-2.09	-2.92	-1.67	-0.41	0.42	1.52	210

DIMENSIONS BASED ON 48' ROADWAY
 * WITH 6' MEDIAN
 ** WITH 14' MEDIAN

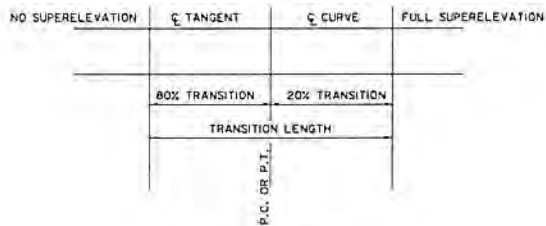

PLAN OF RUNOFF

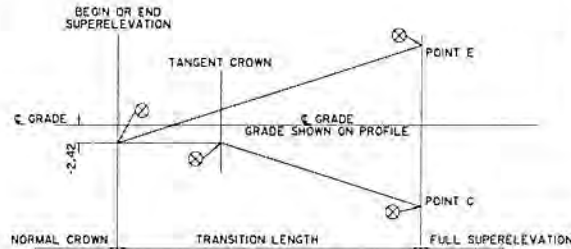


DIAGRAM OF SUPERELEVATION
 (NOT TO SCALE)

⊗ 100' V.C. REQ'D AT ANGULAR BREAKS IN PROFILE OR EDGE OF EMBANKMENT AND PAVEMENT.


PERMIT SKETCHES

PRELIMINARY	Louisiana Department of Transportation and Development
FOR PERMITTING PURPOSES ONLY	PROJECT: KANSAS LINE EXTENSION SHEET: 29 DATE: 11/16

Preliminary Plans
 Subject to Change
 Road Design

PROJECT NO.	29
DISTRICT	DUACHITA
SECTION	
DATE	11/16
BY	
CHECKED	
DESIGNED	
IN CHARGE	
SCALE	
PROJECT TITLE	KANSAS LINE EXTENSION
SHEET NO.	29
TOTAL SHEETS	42
DATE	11/16
PROJECT NO.	H-007289

PERMIT SKETCHES

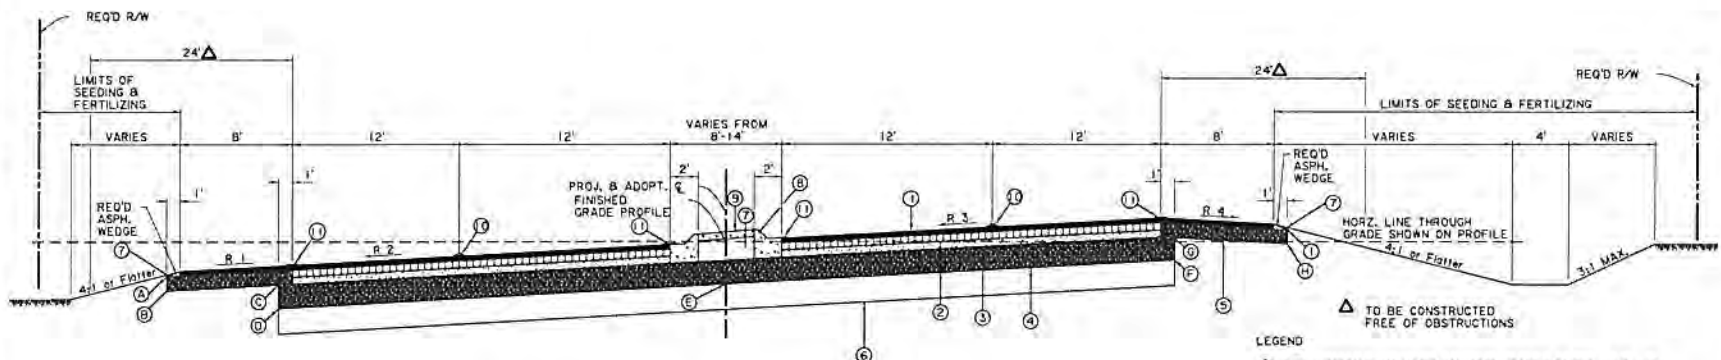

SUPERELEVATED SECTION (N.T.S.)
 APPLIES STA. 137+00.00 TO STA. 138+14.00 (SUPER 3.7%)
 APPLIES STA. 170+26.00 TO STA. 182+15.00 (SUPER 3.7%)
 APPLIES STA. 199+05.00 TO STA. 205+31.35 (SUPER 2.9%)
 APPLIES STA. 216+77.62 TO STA. 227+30.00 (SUPER 3.2%)



LEGEND

- ① 2 IN. SUPERPAVE ASPHALTIC CONCRETE WEARING COURSE, LEVEL 1F
- ② 3 IN. SUPERPAVE ASPHALTIC CONCRETE BINDER COURSE, LEVEL 1
- ③ 3 IN. SUPERPAVE ASPHALTIC CONCRETE BASE COURSE, LEVEL 1
- ④ 10 IN. CLASS II BASE COURSE (STONE OR RECYCLED P.C.C.)
- ⑤ 6 IN. CLASS II BASE COURSE (STONE OR RECYCLED P.C.C.)
- ⑥ 12 IN. SUBGRADE LAYER (TREATED) USE AS DIRECTED BY PROJ. ENG.
- ⑦ EMBANKMENT
- ⑧ COMBINATION CURB & GUTTER (MOUNTABLE)
- ⑨ 6 IN. INCIDENTAL CONCRETE (W/RED PIGMENT)
- ⑩ PAVEMENT STRIPING & REFLECTORIZED MARKERS
- ⑪ PAVEMENT STRIPING

SUPERELEVATION DETAILS (IN FEET) WITH REFERENCE TO HORIZONTAL LINE THROUGH GRADE SHOWN ON PROFILE

RADIUS	R 1	R 2	R 3	R 4	A	B	C	D	E	F	G	H	I	TRANSITION LENGTH
-	NC	NC	NC	NC	-1.42	-1.89	-1.49	-2.30	-1.50	-2.30	-1.49	-1.89	-1.42	NA
1000'	5.00%	3.70%	3.70%	-3.30%	-1.69	-2.15	-1.75	-2.57	-1.50	-0.43	0.34	0.07	0.52	210
1500'	5.00%	3.20%	3.20%	-3.80%	-1.64	-2.11	-1.71	-2.92	-1.50	-0.49	0.29	-0.02	0.44	190
2000'	5.00%	2.90%	2.90%	-4.10%	-1.46	-1.93	-1.53	-2.34	-1.50	-0.65	0.12	-0.21	0.25	180

DIMENSIONS BASED ON 48' ROADWAY B & B' MEDIAN

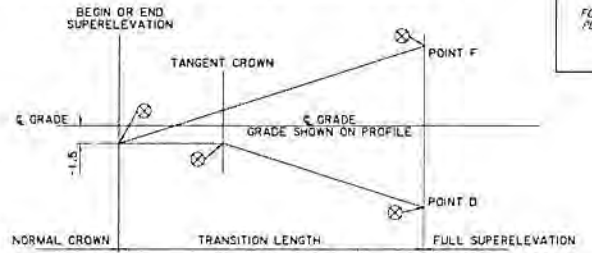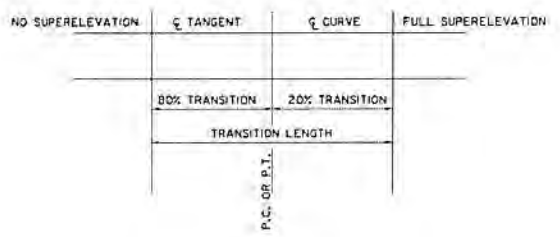

⊗ 100' V.C. REQ'D AT ANGULAR BREAKS IN PROFILE OR EDGE OF EMBANKMENT AND PAVEMENT.

PERMIT SKETCHES

PRELIMINARY	Louisiana Department of Transportation and Development
FOR PERMITTING PURPOSES ONLY	ENGINEER: THOMAS HANAUER LICENSE # 20841 DATE: 11-24-2017


Preliminary Plans
 Subject to Change
 Road Design

SHEET NO.	21
PROJECT NO.	DUACHITA
DATE	11/17/16
DRAWN BY	J.M.B.
CHECKED BY	J.M.B.
SCALE	AS SHOWN
PROJECT LOCATION	KANSAS LINE EXTENSION
PROJECT DESCRIPTION	TYPICAL SECTION WITH 8' RAISED MEDIAN ASPHALTIC CONCRETE PAVEMENT
PROJECT NO.	H-007289


PERMIT SKETCHES
 1:24=1' (PLAN) 1:12=1' (PROFILE)
 1:24=1' (PLAN) 1:12=1' (PROFILE)

PERMIT SKETCHES

PRELIMINARY FOR PERMITTING PURPOSES ONLY	Louisiana Department of Transportation and Development PROJECT: THOMAS HANAWAY LICENSE # 10000 DATE: 12/10/11
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TYPICAL GRADING SECTION (N.T.S.)
 APPLIES STA. 304+39.67 TO STA. 311+20.96

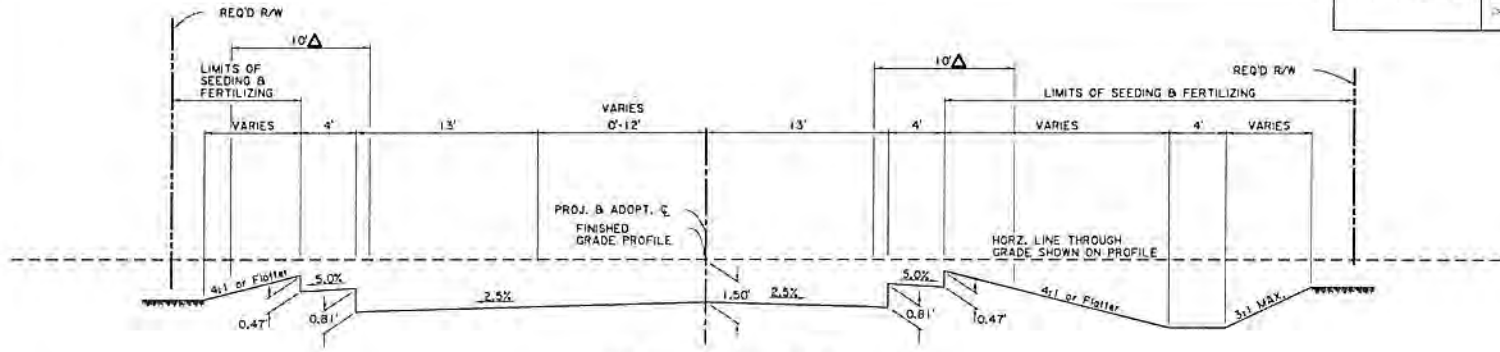

TYPICAL FINISHED SECTION (N.T.S.)
 APPLIES STA. 304+39.67 TO STA. 311+20.96

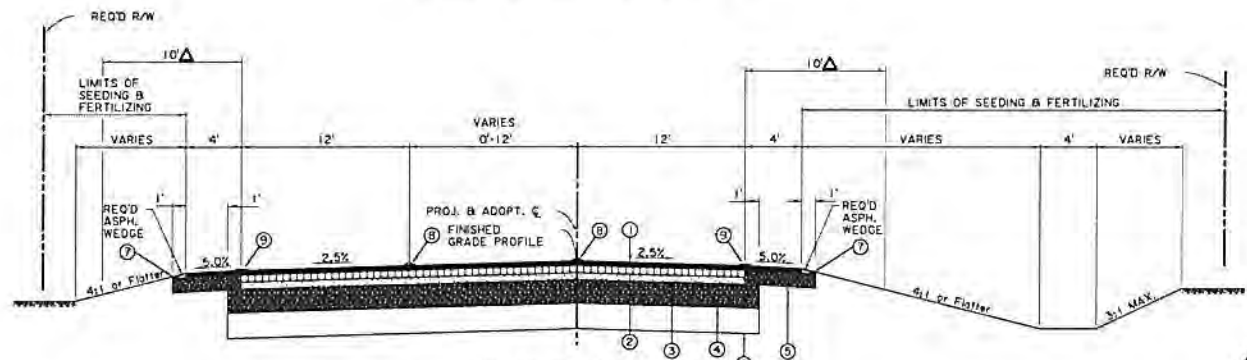FLEXIBLE STRUCTURAL DESIGN

CURRENT ADT	= 4,450
MEDIUM ADT	= 7,745
DESIGN ADT	= 11,060
PERFORMANCE PERIOD (YEARS)	= 20
18 KD ESALS	= 1,120.74
ESALS OVER DESIGN LIFE (MTR)	= 8,177,760.03
SOIL RESILIENT MODULUS (PSI)	= 10,000
STRUCTURAL NO. REQUIRED (INCHES)	= 4.6
STRUCTURAL NO. PROVIDED (INCHES PER LAYER)	
1 - WEARING COURSE, SUPERPAVE	= 0.88
2 - BINDER COURSE, SUPERPAVE	= 1.32
3 - BASE COURSE, SUPERPAVE	= 0.99
4 - BASE COURSE, IN-PLACE CEMENT TREATED	= 1.40
STRUCTURAL NO. PROVIDED (TOTAL INCHES)	= 4.59


- LEGEND
- ① 2 IN. SUPERPAVE ASPHALTIC CONCRETE WEARING COURSE, LEVEL 1F
 - ② 3 IN. SUPERPAVE ASPHALTIC CONCRETE BINDER COURSE, LEVEL 1
 - ③ 3 IN. SUPERPAVE ASPHALTIC CONCRETE BASE COURSE, LEVEL 1
 - ④ 10 IN. CLASS II BASE COURSE (STONE OR RECYCLED P.C.C.)
 - ⑤ 6 IN. CLASS II BASE COURSE (STONE OR RECYCLED P.C.C.)
 - ⑥ 12 IN. SUBGRADE LAYER (TREATED) (USE AS DIRECTED BY PROJ. ENG.)
 - ⑦ EMBANKMENT
 - ⑧ PAVEMENT STRIPING & REFLECTORIZED MARKERS
 - ⑨ PAVEMENT STRIPING

△ TO BE CONSTRUCTED FREE OF OBSTRUCTIONS

Preliminary Plans
 Subject to Change
Road Design

SHEET NUMBER	DUACHITA	PROJECT NUMBER	H.007289	DATE	11/15	SCALE	AS SHOWN	DATE	11/15	SCALE	AS SHOWN
TYPICAL SECTION OLD STERLINGTON ROAD ASPHALTIC CONCRETE PAVEMENT KANSAS LANE EXTENSION											

PERMIT SKETCHES

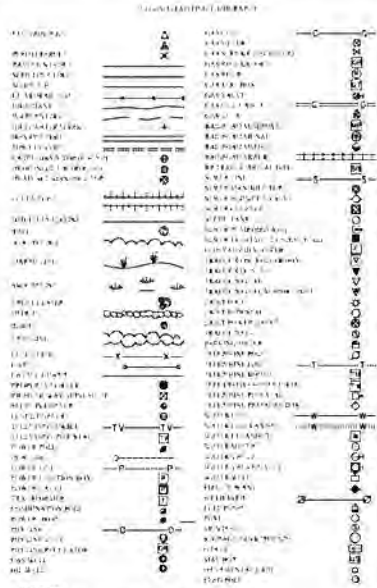

NOTES:
ALL EXISTING DRAINAGE STRUCTURES WITHIN LIMITS OF NEW CONSTRUCTION TO BE REMOVED, UNLESS NOTED OTHERWISE.

SUMMARY OF DRAINAGE STRUCTURES AND PIPE TO BE REMOVED (FOR INFORMATION ONLY)


PIPES (DIA.)	PIPE LENGTH
12"	234'
15"	84'
18"	500'
24"	94'
30"	92'
36"	614'
42"	86'

26 CATCH BASINS

LA ONE CALL


UTILITY COMPANYS

- ATMOS (GAS)
- AT&T DISTRIBUTIONS
- CABLE MANAGEMENT ASSOCIATION
- CENTURY TELEPHONE
- CITY OF MONROE
- COH9 LOUISIANA PRODUCTION (GAS)
- CROSS TEX LIG
- ENERGY
- MCLEOD USA (FIBER OPTIC)
- TIME WARNER CABLE
- TOWN & COUNTRY SERVICE CO.

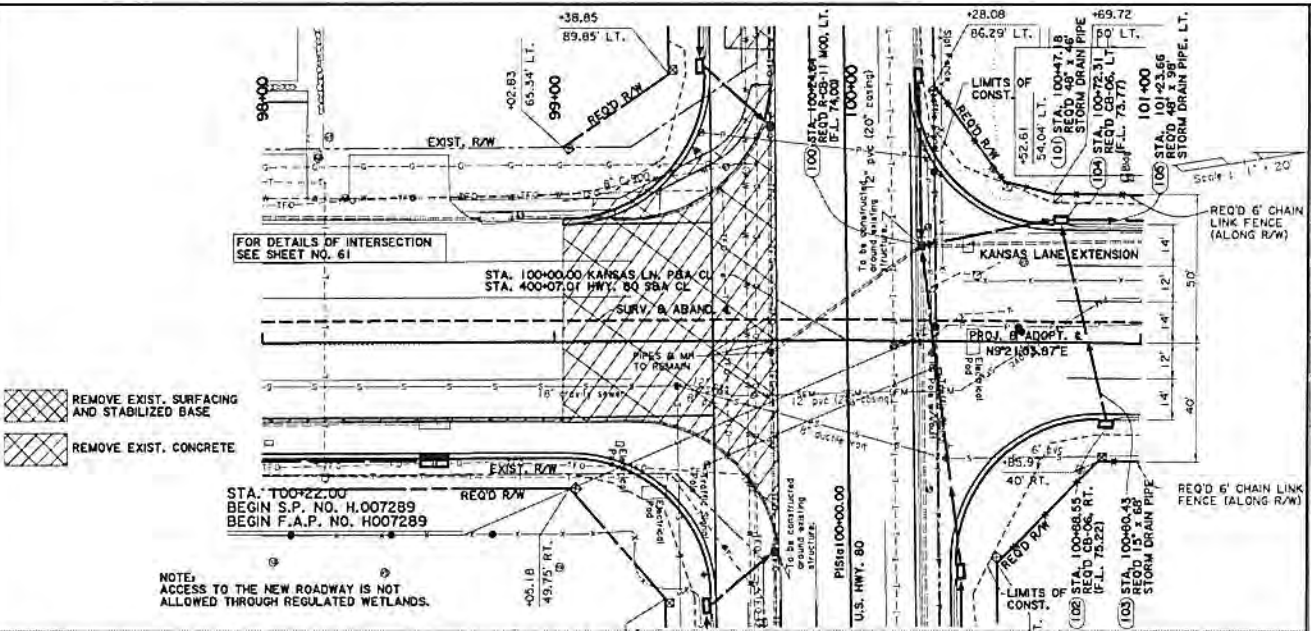

REMOVE EXIST. SURFACING AND STABILIZED BASE
REMOVE EXIST. CONCRETE

NOTE:
ACCESS TO THE NEW ROADWAY IS NOT ALLOWED THROUGH REGULATED WETLANDS.

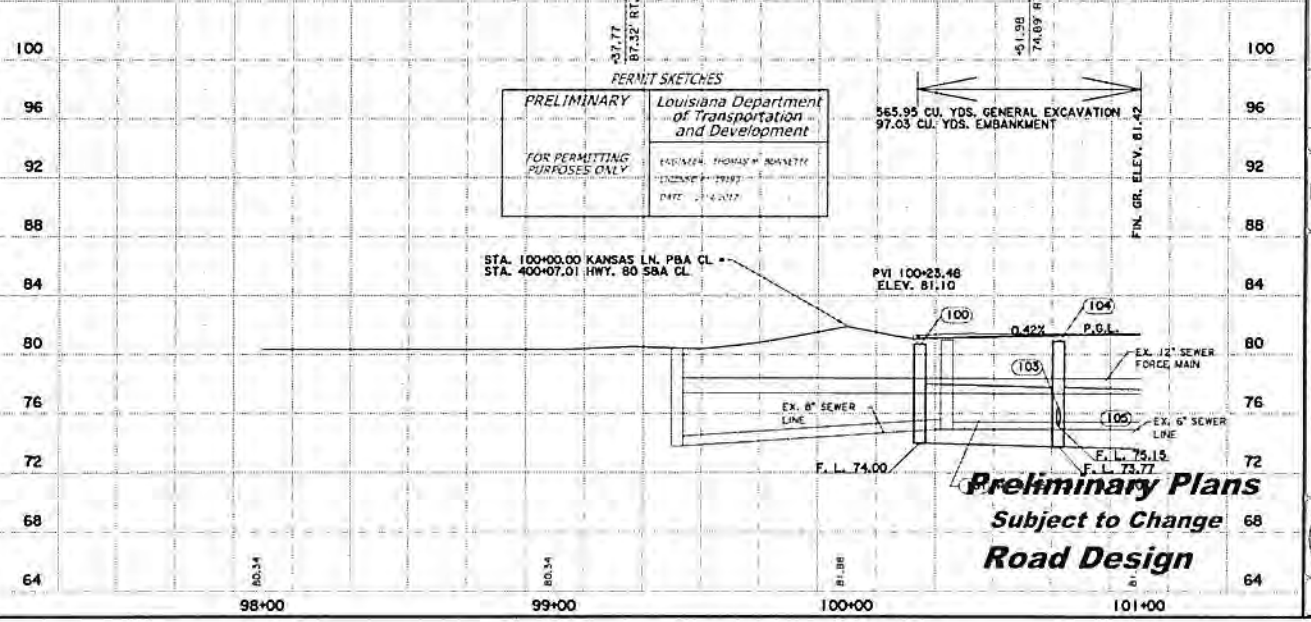

PERMIT SKETCHES

PRELIMINARY Louisiana Department of Transportation and Development

FOR PERMITTING PURPOSES ONLY

ENGINEER: THOMAS W. BARNETT

DESIGNER: J. BRYANT

DATE: 11/16/16


STA. 100+00.00 KANSAS LN. P&A CL
STA. 400+07.01 HWY. 80 S&A CL

PVI 100+23.46
ELEV. 81.10

Preliminary Plans
Subject to Change
Road Design

DATE	11/16	BY	JTB
SCALE	AS SHOWN	CHECKED	JTB
PROJECT	KANSAS LANE EXTENSION		
DESIGNER	DOTD		
ENGINEER	THOMAS W. BARNETT		
PROJECT NO.	H-007289		
SHEET NO.	4		

116+00 117+00 118+00 119+00 120+00 121+00
 52 56 60 64 68 72 76 80 84 88 92
 PERMIT SKETCHES
 116+00 117+00 118+00 119+00 120+00 121+00
 52 56 60 64 68 72 76 80 84 88 92

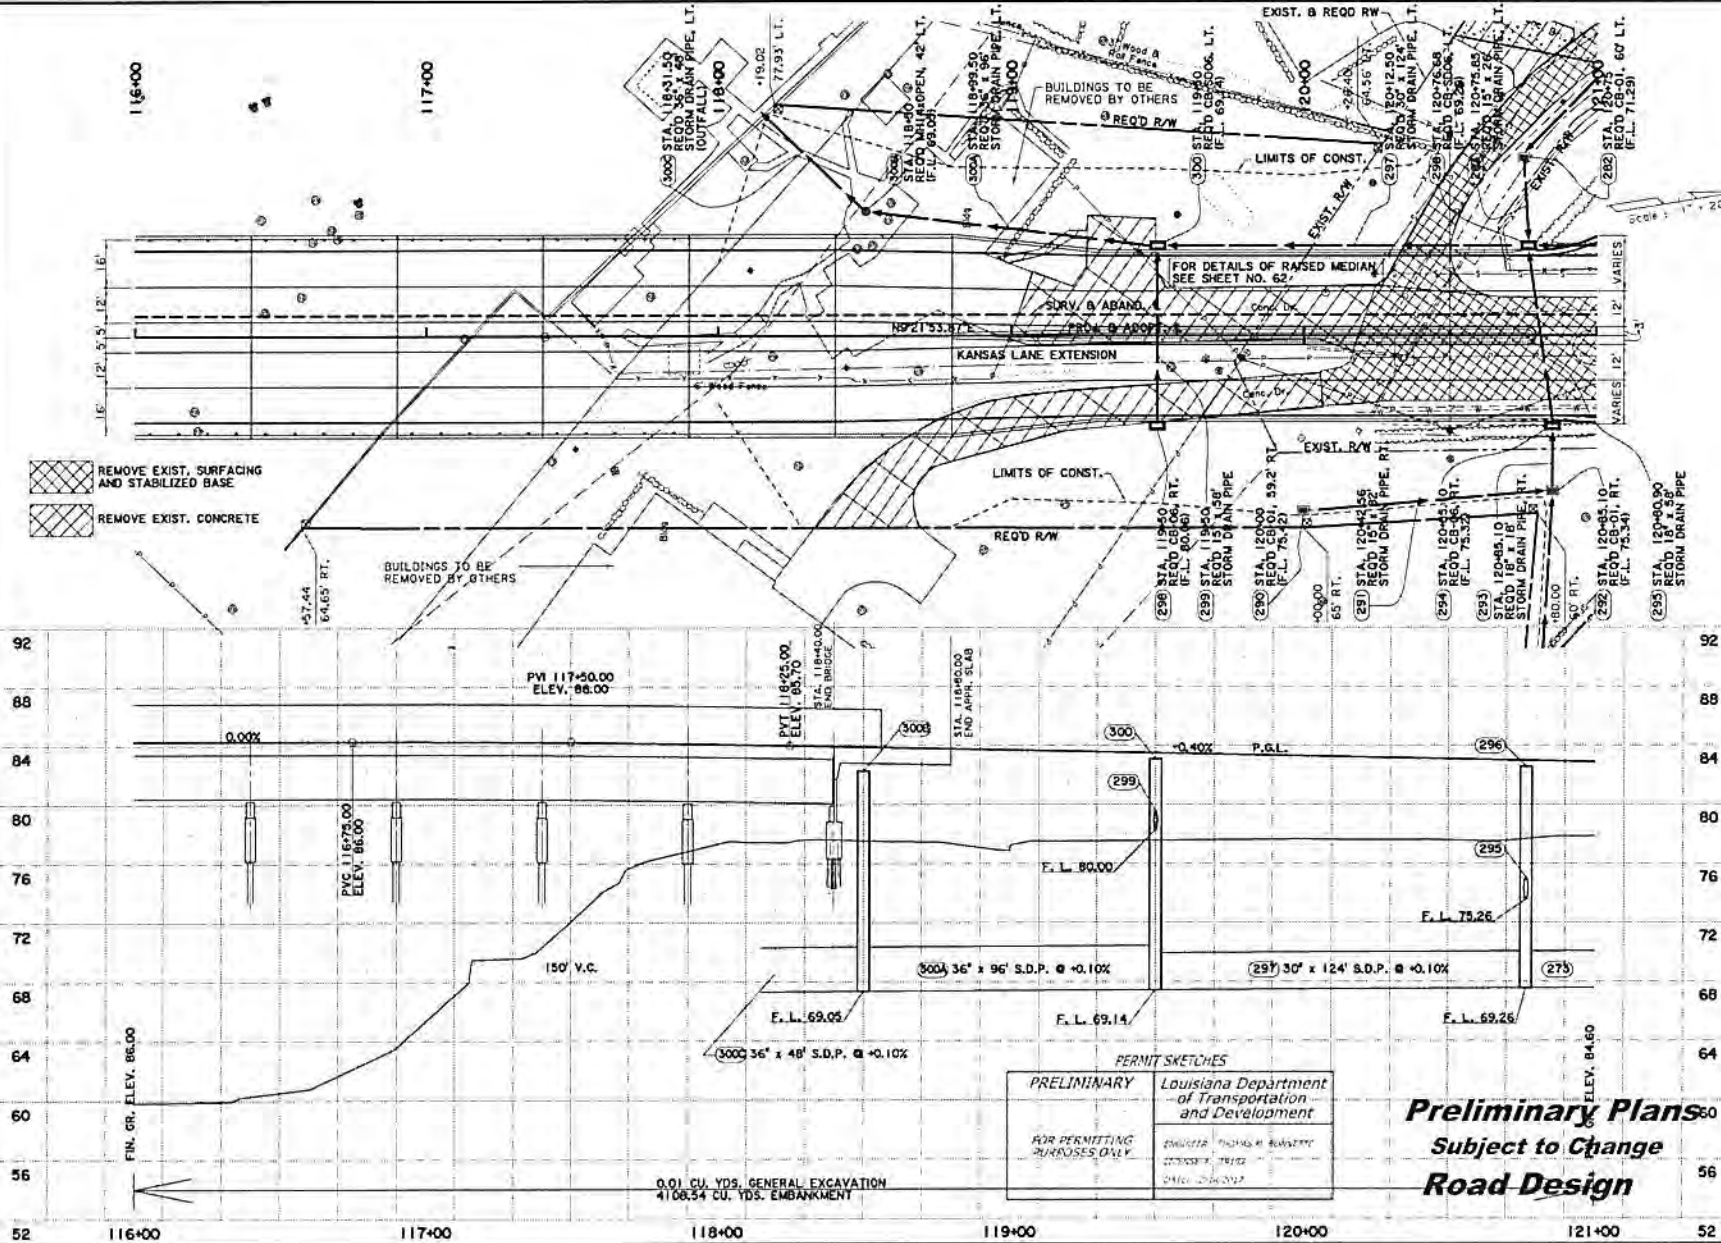

- REMOVE EXIST. SURFACING AND STABILIZED BASE
- REMOVE EXIST. CONCRETE


PERMIT SKETCHES

PRELIMINARY FOR PERMITTING PURPOSES ONLY	Louisiana Department of Transportation and Development PROJECT: KANSAS LANE EXTENSION DATE: 2-26-2017
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Preliminary Plans
 Subject to Change
 Road Design

PROJECT	DUACHITA	DATE	1/17/16	DRAWN BY	H.007269
DESIGNED	LMR	CHECKED	CDP	DATE	1/17/16
APPROVED	LMR	DATE	1/17/16	SCALE	AS SHOWN
KANSAS LANE PLAN AND PROFILE KANSAS LANE EXTENSION					



PERMIT SKETCHES

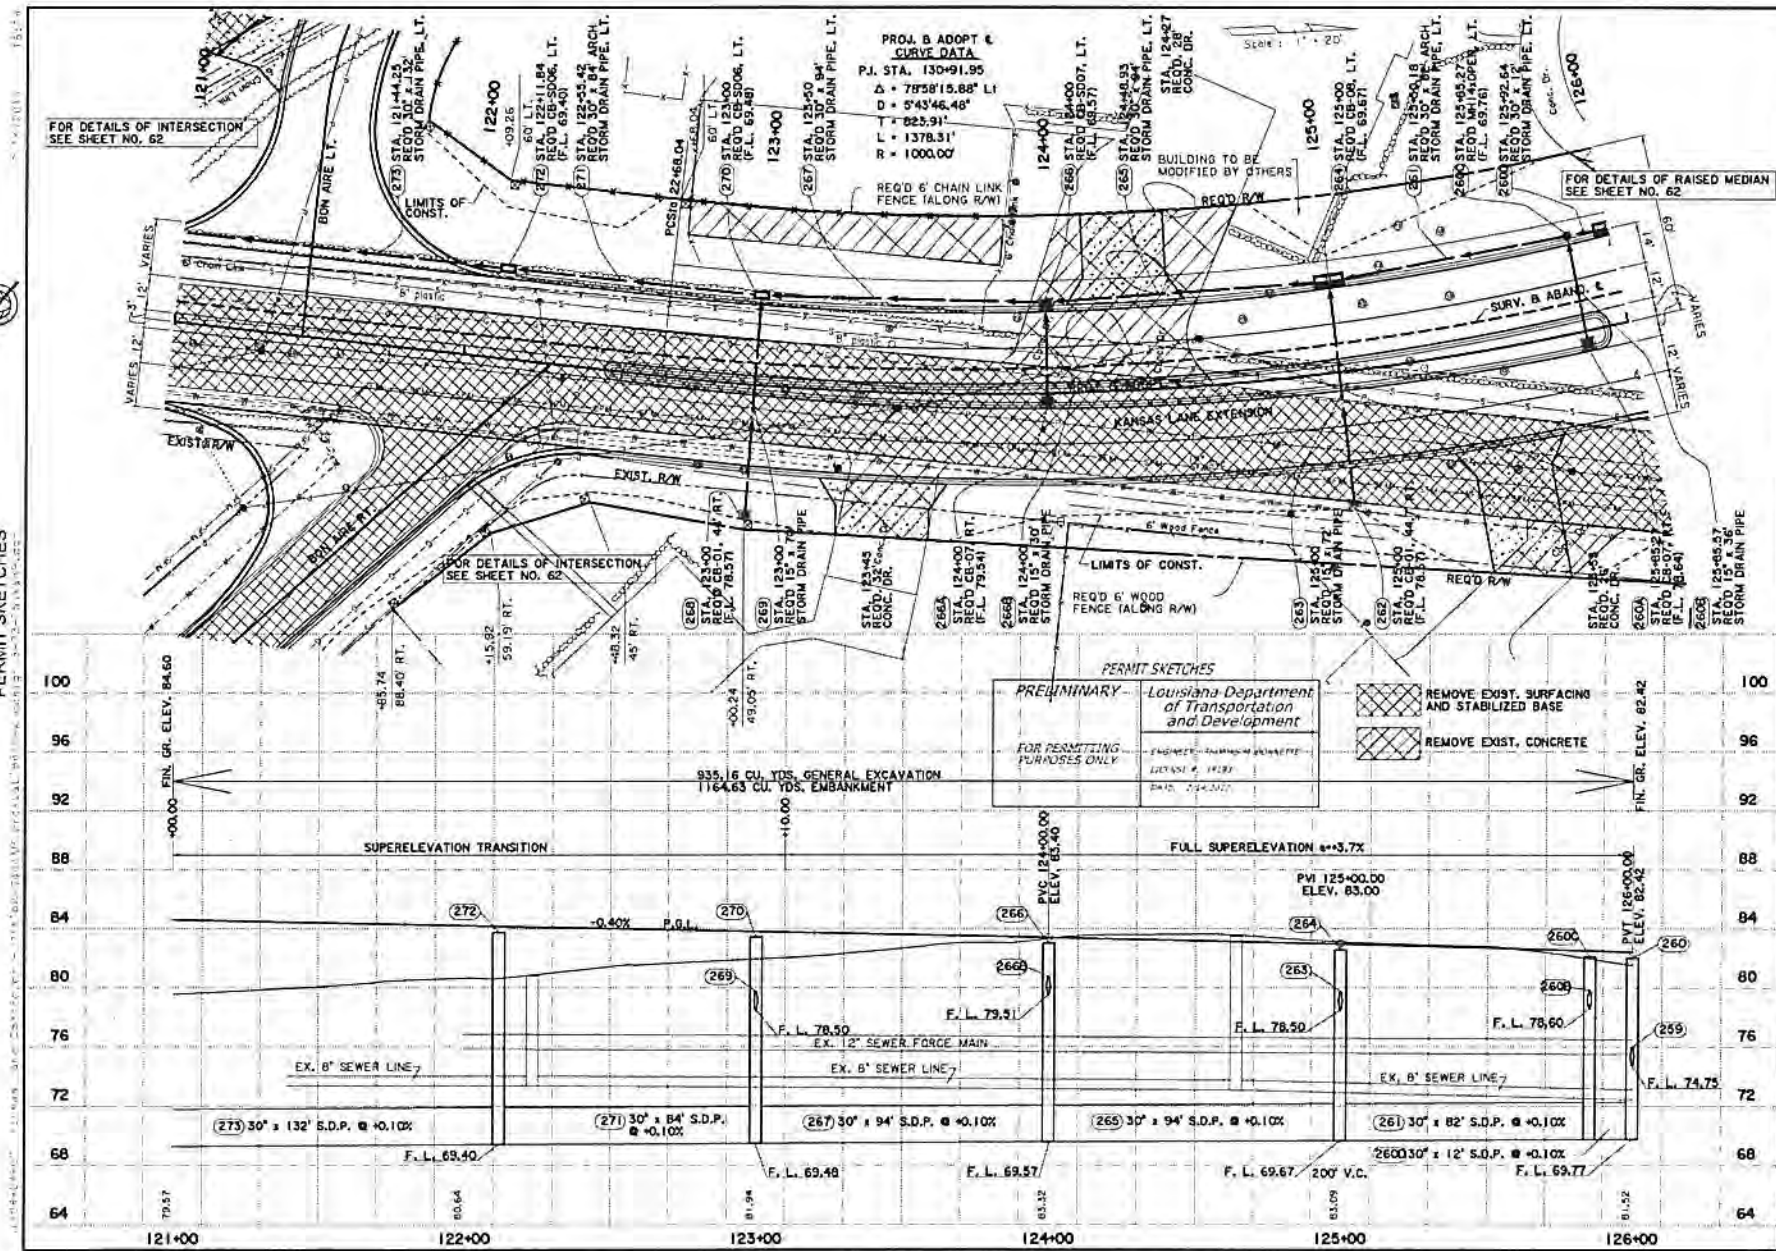

PROJECT NO.	11716	DATE	11/76
DESIGNED BY	LMG	CHECKED BY	LMG
DRAWN BY	LMG	SCALE	AS SHOWN
DATE	11/76	PROJECT	KANSAS LANE EXTENSION
NO.	9	PROJECT	KANSAS LANE EXTENSION

PERMIT SKETCHES

PROJ. & ADOPT. & CURVE DATA
 P.I. STA. 130+91.95
 $\Delta = 78^{\circ}58'15.88''$ L
 $D = 5^{\circ}43'46.48''$
 $T = 823.91'$
 $L = 1378.31'$
 $R = 1000.00'$

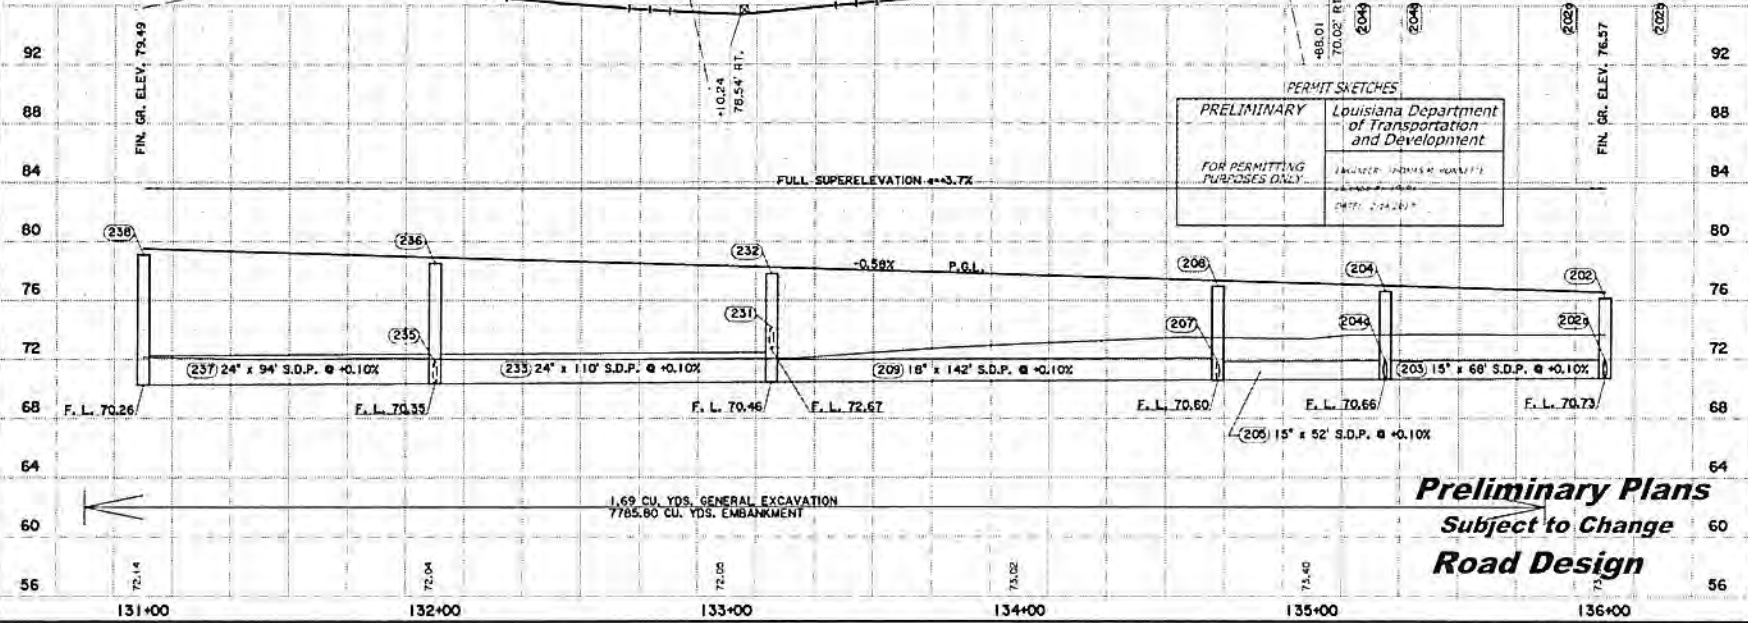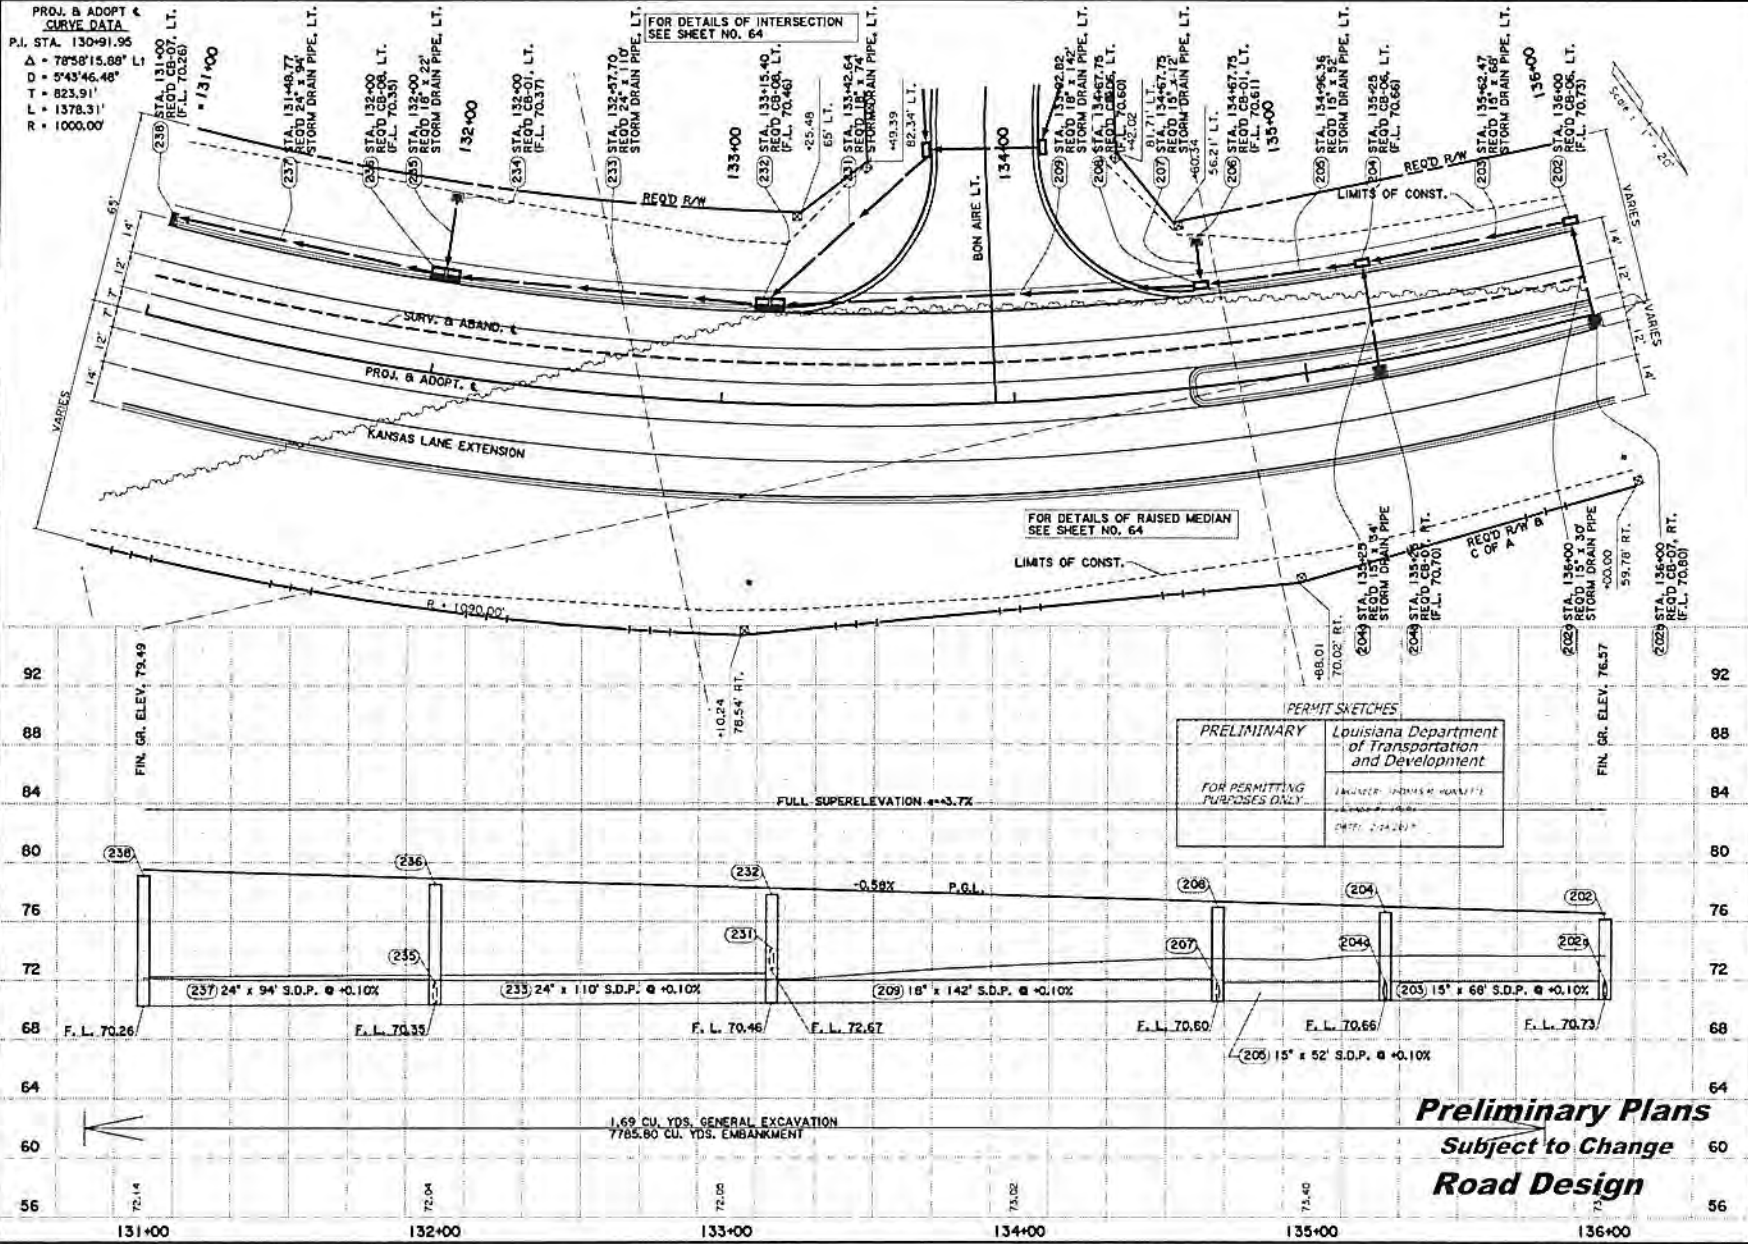

PRELIMINARY Louisiana Department of Transportation and Development
 FOR PERMITTING PURPOSES ONLY

1.69 CU. YDS. GENERAL EXCAVATION
 7785.80 CU. YDS. EMBANKMENT

Preliminary Plans
 Subject to Change
Road Design



NO. 1	DATE	BY	CHKD.	APP'D.	REVISION
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KANSAS LANE
 PLAN AND PROFILE
 KANSAS LANE EXTENSION



NO. 1	DATE	BY	CHKD.	APP'D.	REVISION
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PERMIT SKETCHES
 3-22-2017 1:22
 3-22-2017 1:22
 3-22-2017 1:22



PERMIT SKETCHES
 PRELIMINARY
 FOR PERMITTING PURPOSES ONLY
 Louisiana Department of Transportation and Development
 PAULINE THOMAS H. BOUTTE
 LICENSE # 11482
 DATE 3/22/17

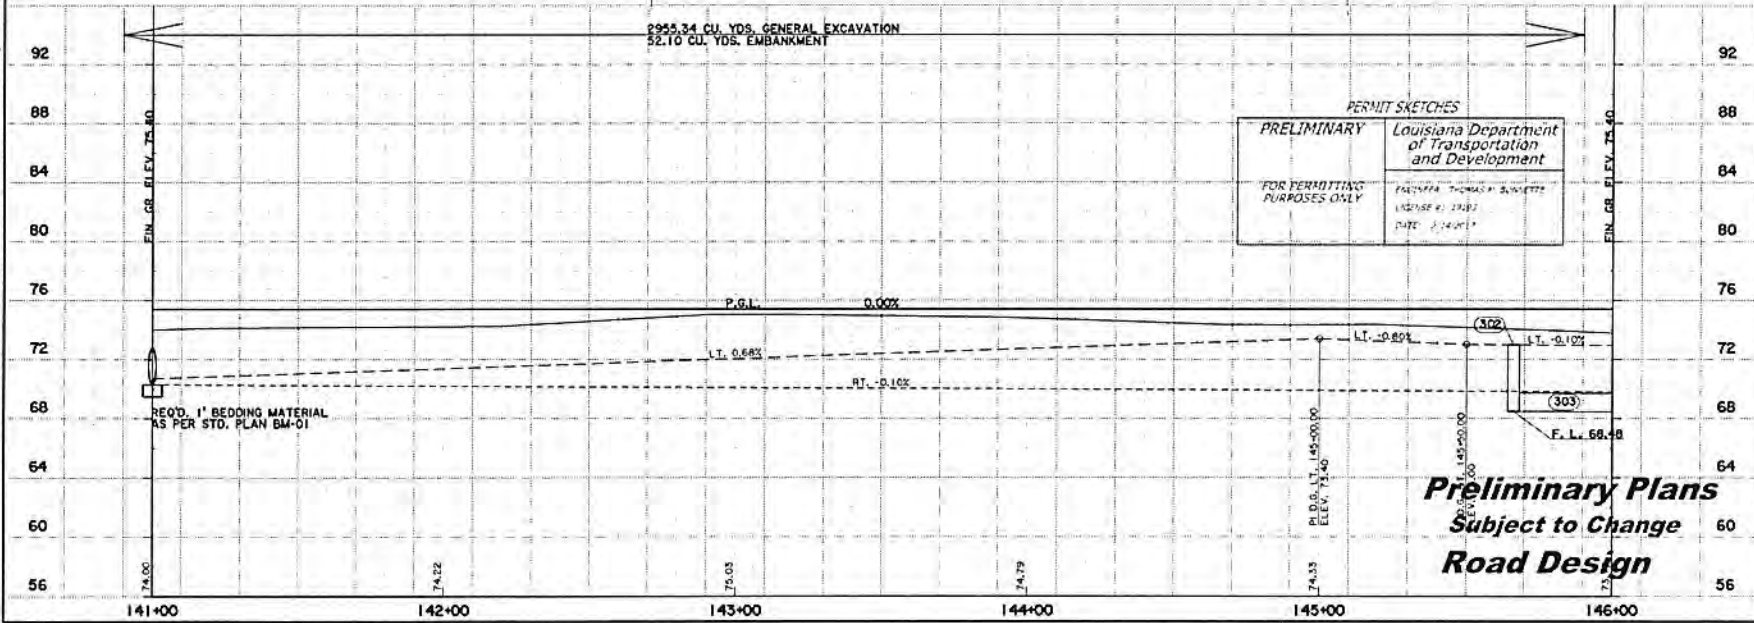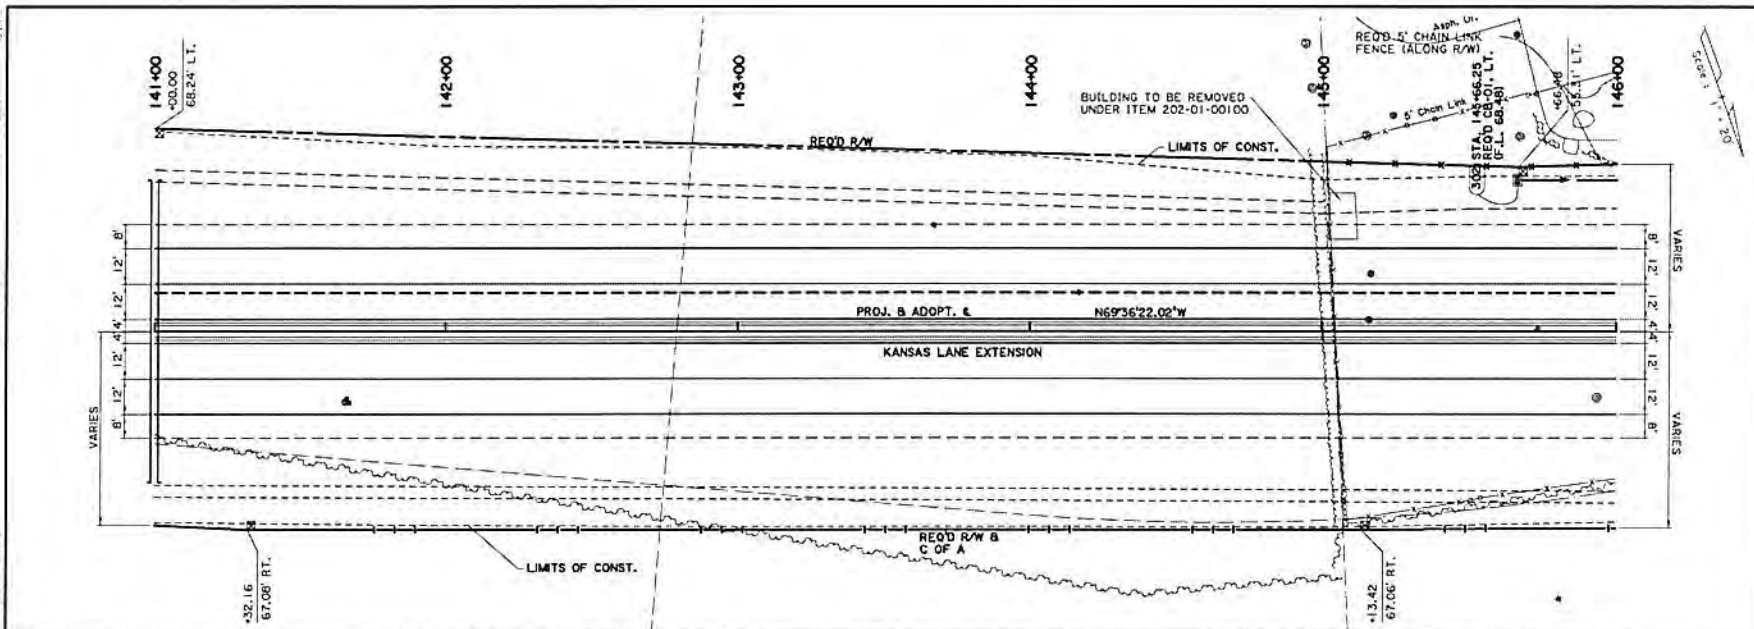Preliminary Plans
 Subject to Change
Road Design


SHEET NUMBER	13
PROJECT	KANSAS LANE EXTENSION
DATE	3/22/17
DESIGNED BY	PAULINE THOMAS H. BOUTTE
CHECKED BY	
IN CHARGE	
APPROVED BY	
PROJECT	DUACHITA
PROJECT	H.007289



KANSAS LANE
 PLAN AND PROFILE
 KANSAS LANE EXTENSION



PERMIT SKETCHES

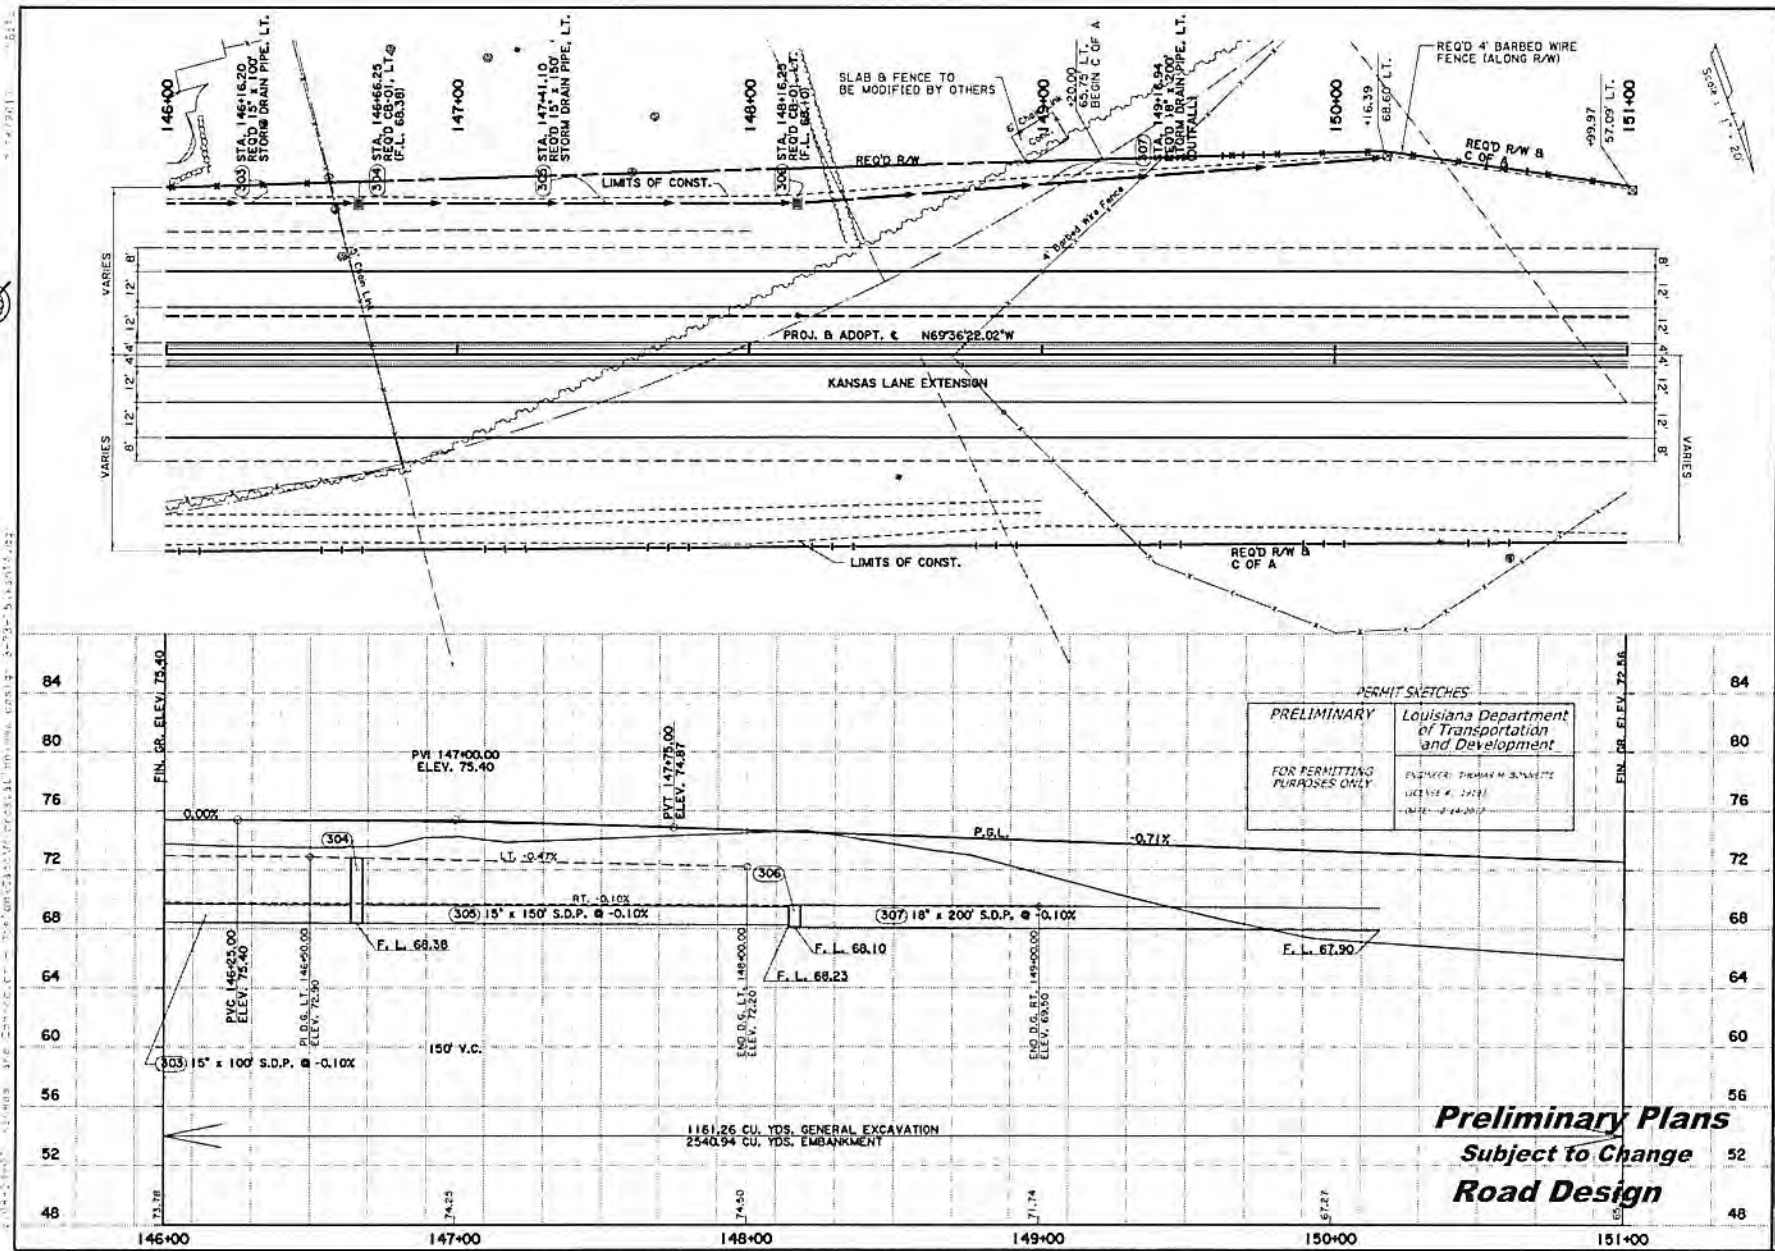


PERMIT SKETCHES
 PRELIMINARY
 FOR PERMITTING PURPOSES ONLY
 Louisiana Department of Transportation and Development
 ENGINEER: THOMAS M. BUNNELL
 LICENSE # 12121
 DATE: 2-14-2023

Preliminary Plans
 Subject to Change
 Road Design

PROJECT NO.	14
CITY	DUACHITA
DATE	1/17/23
SCALE	H. 007269
DESIGNER	
CHECKER	
APPROVER	
DATE	
NO.	31
DATE	
PROJECT NAME	KANSAS LANE EXTENSION
PROJECT LOCATION	KANSAS LANE EXTENSION

1:15=1" HORIZ. AND 1"=20' VERT. (VERTICAL CURVE DATA: PVI 179+00.00, ELEV. 72.30, L=150', G=-0.40%, G2=0.32%, PVI 179+00.00, ELEV. 72.30, L=150', G=-0.40%, G2=0.32%)
 PERMIT SKETCHES
 11/16/17


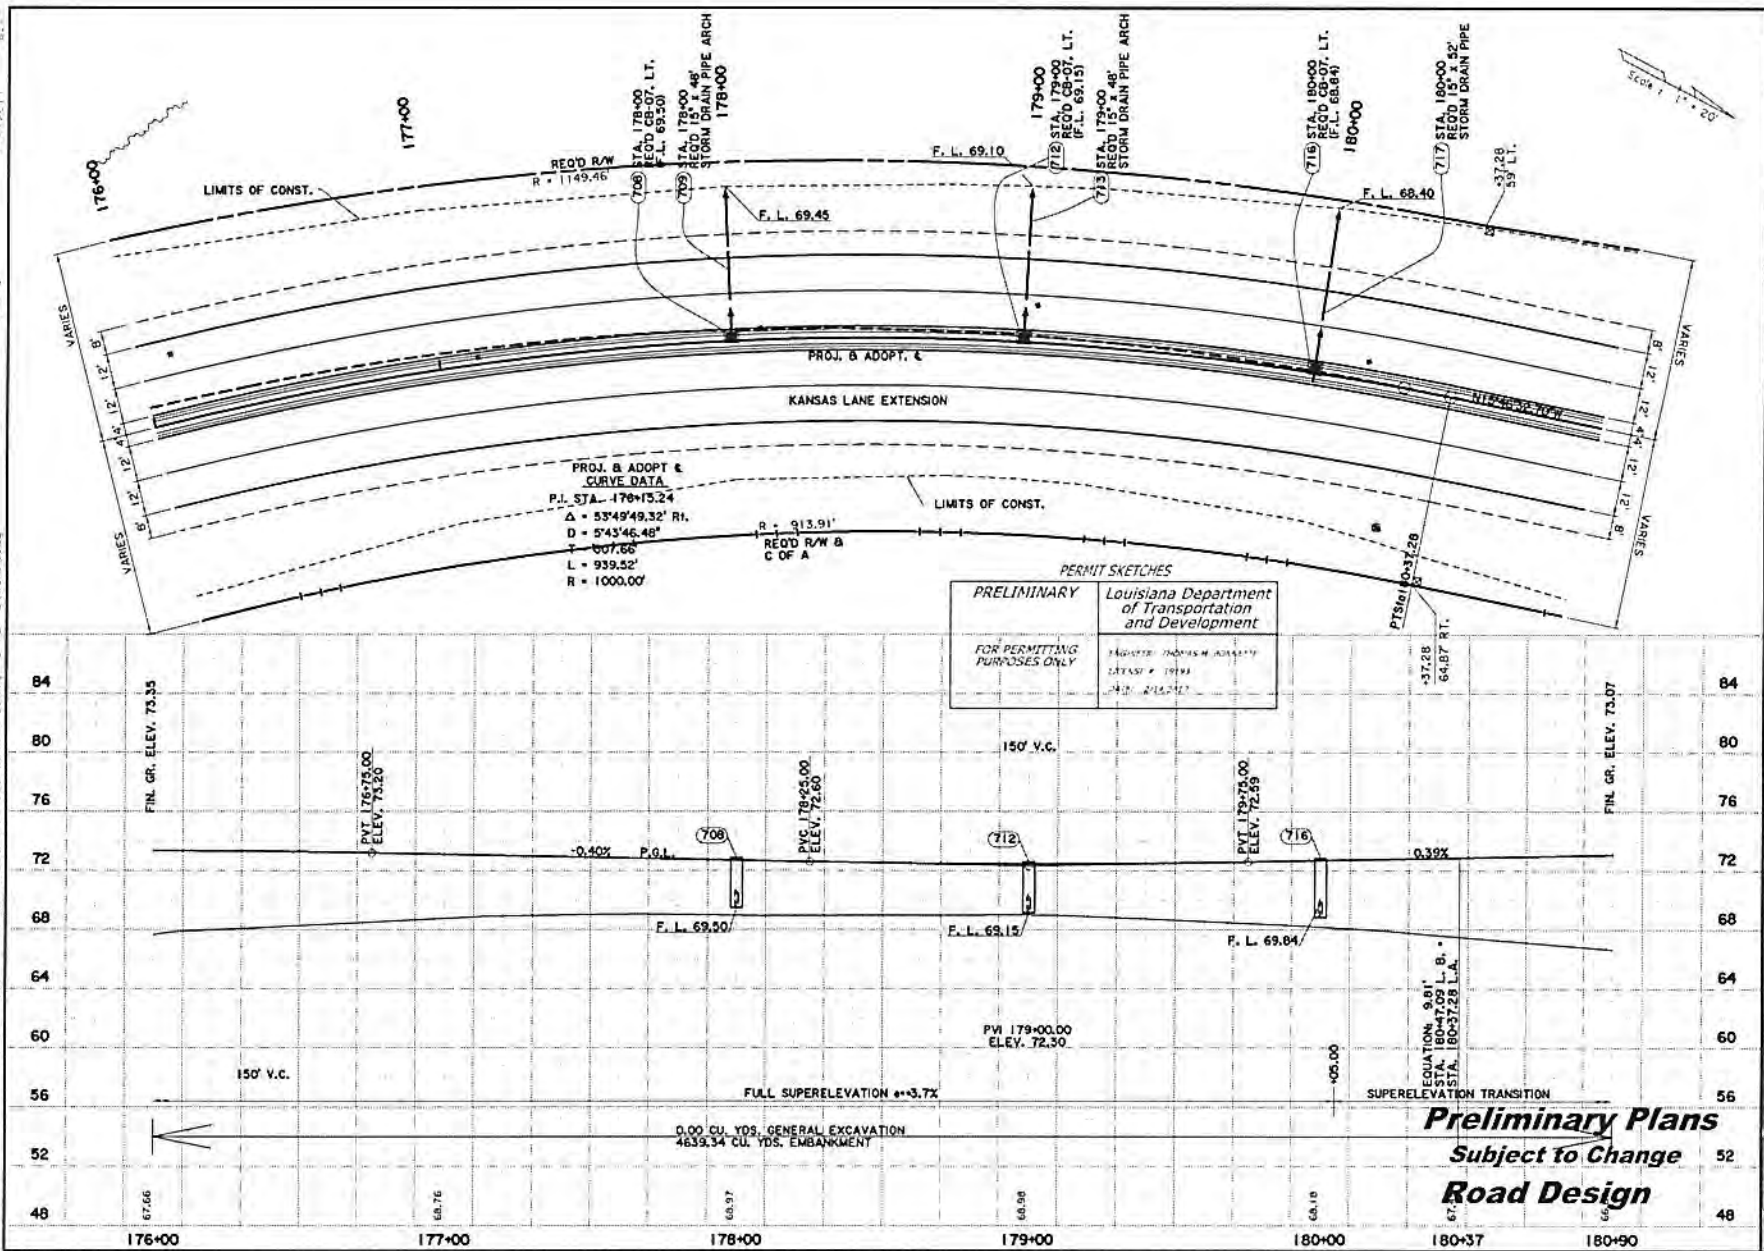


PRELIMINARY
 FOR PERMITTING PURPOSES ONLY
 Louisiana Department of Transportation and Development
 PROJECT: TRANSPORTATION DISTRICT # 10984
 DATE: 11/16/17

Preliminary Plans
 Subject to Change
Road Design

DATE	11/16	BY	H.M.T.	CHECKED	H.M.T.	SCALE	1" = 20'
DESIGNED	LMG	CHECKED	LMG	STATIONED	CP	DATE	11/16
PROJECT	QUACHITA	CONTRACT		PROJECT		PROJECT	H-007269
PLAN AND PROFILE	KANSAS LANE EXTENSION						

1.0442(4)417 - 4319444 3100 02/12/2017 1:51:11
 1.0442(4)417 - 4319444 3100 02/12/2017 1:51:11
 PERMIT SKETCHES
 1.0442(4)417 - 4319444 3100 02/12/2017 1:51:11

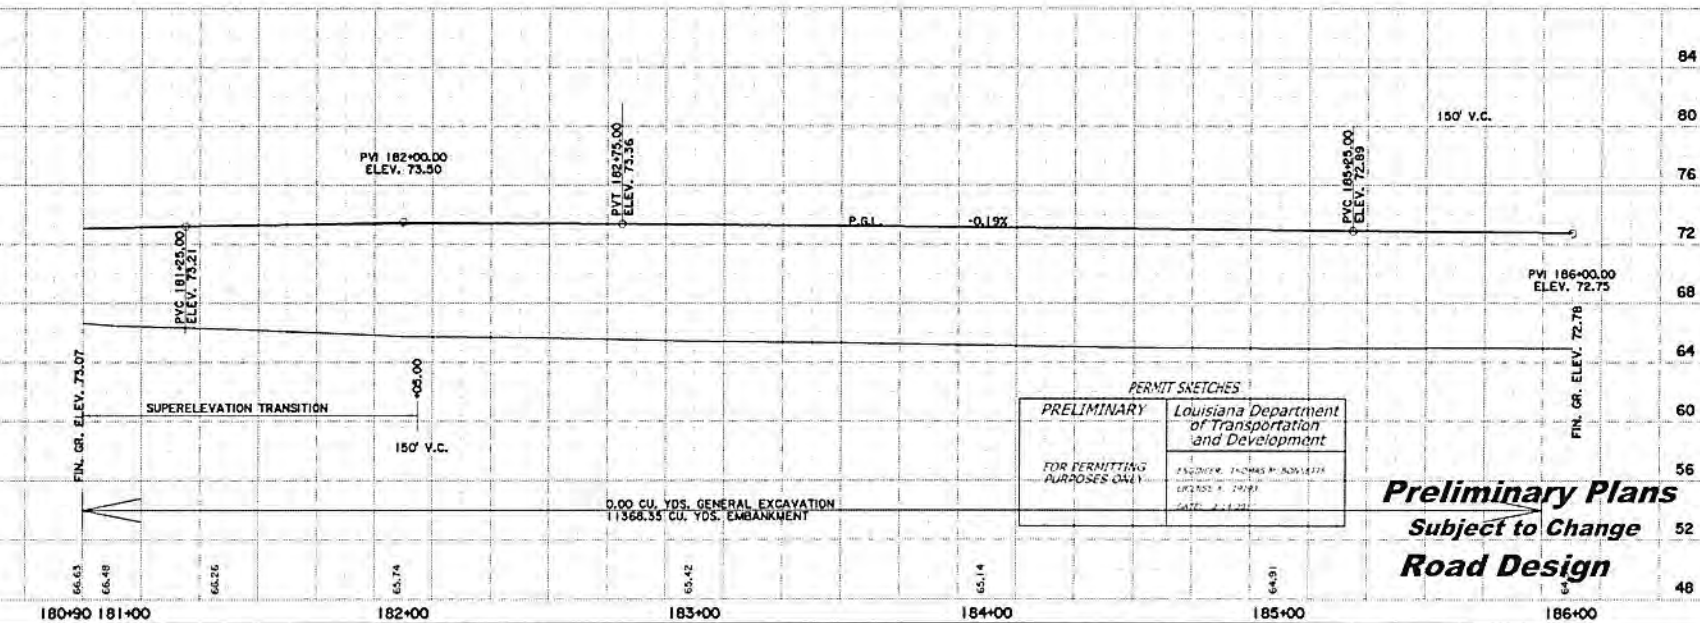
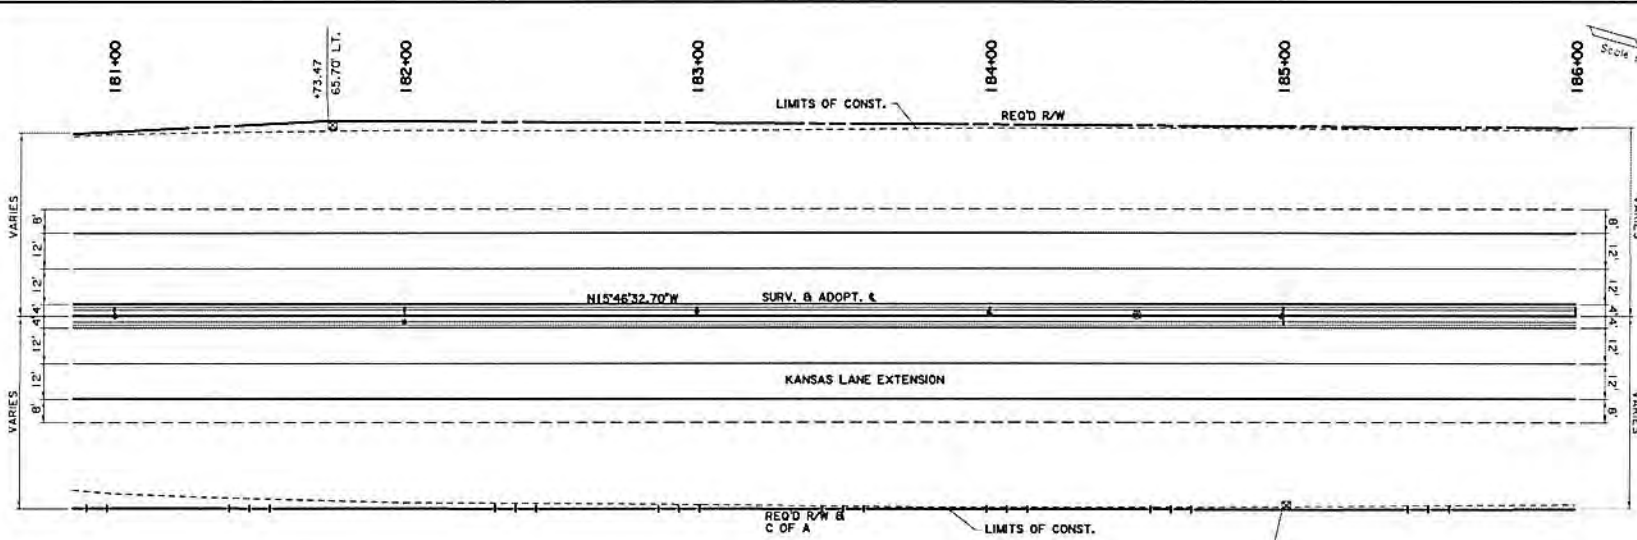


PERMIT SKETCHES
PRELIMINARY
 FOR PERMITTING
 PURPOSES ONLY
 Louisiana Department
 of Transportation
 and Development
 ENGINEER: THOMAS P. BOWLETT
 LICENSE # 20493
 DATE: 2-1-2017

Preliminary Plans
 Subject to Change
Road Design

SHEET NUMBER	21	PROJECT	H-007289
DATE	11/16	SCALE	AS SHOWN
DESIGNED BY	LAG	CHECKED BY	LAG
DRAWN BY	LAG	DATE	11/16
KANSAS LANE PLAN AND PROFILE KANSAS LANE EXTENSION			

1:000-1:400' ADDRESS AND COMPLETION - 11/15/2017
 PERMIT SKETCHES
 11/15/2017

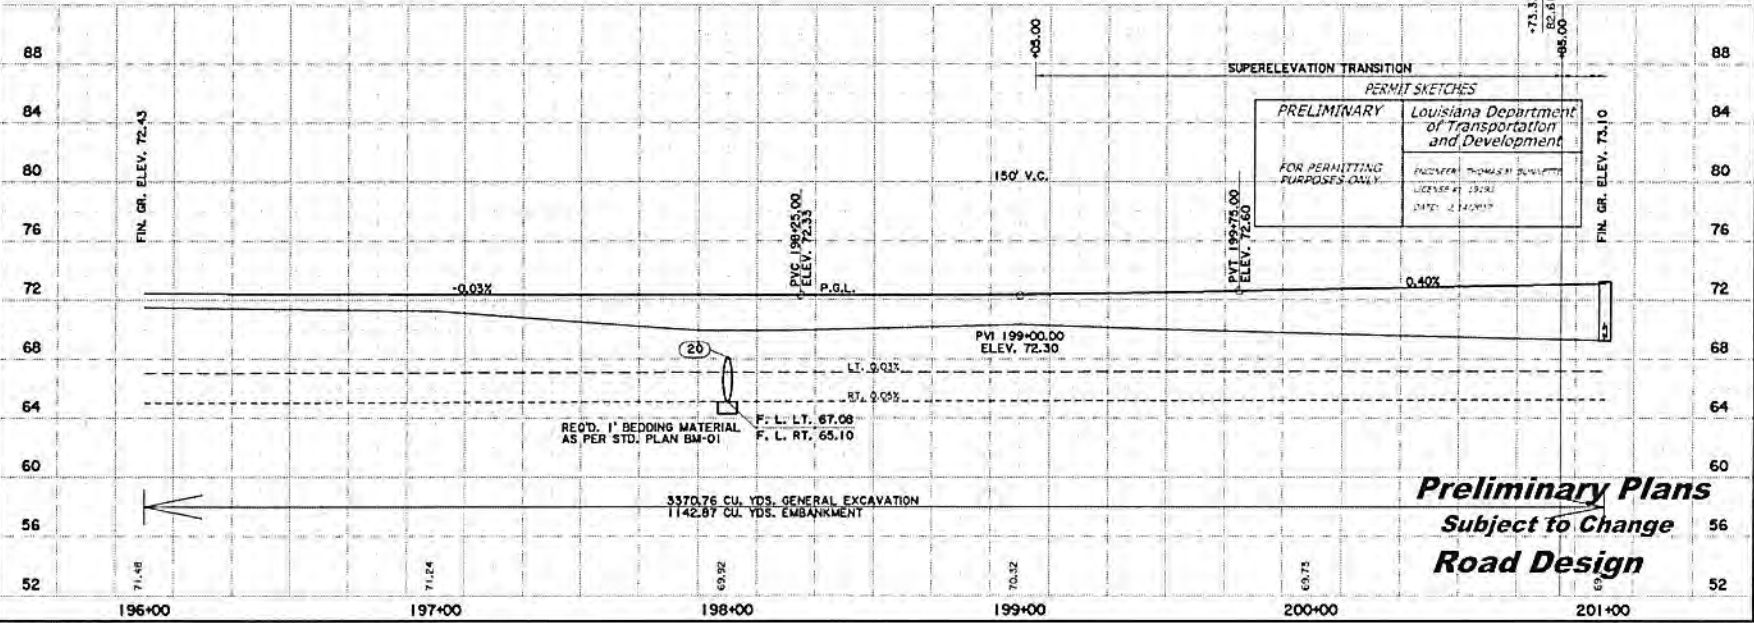
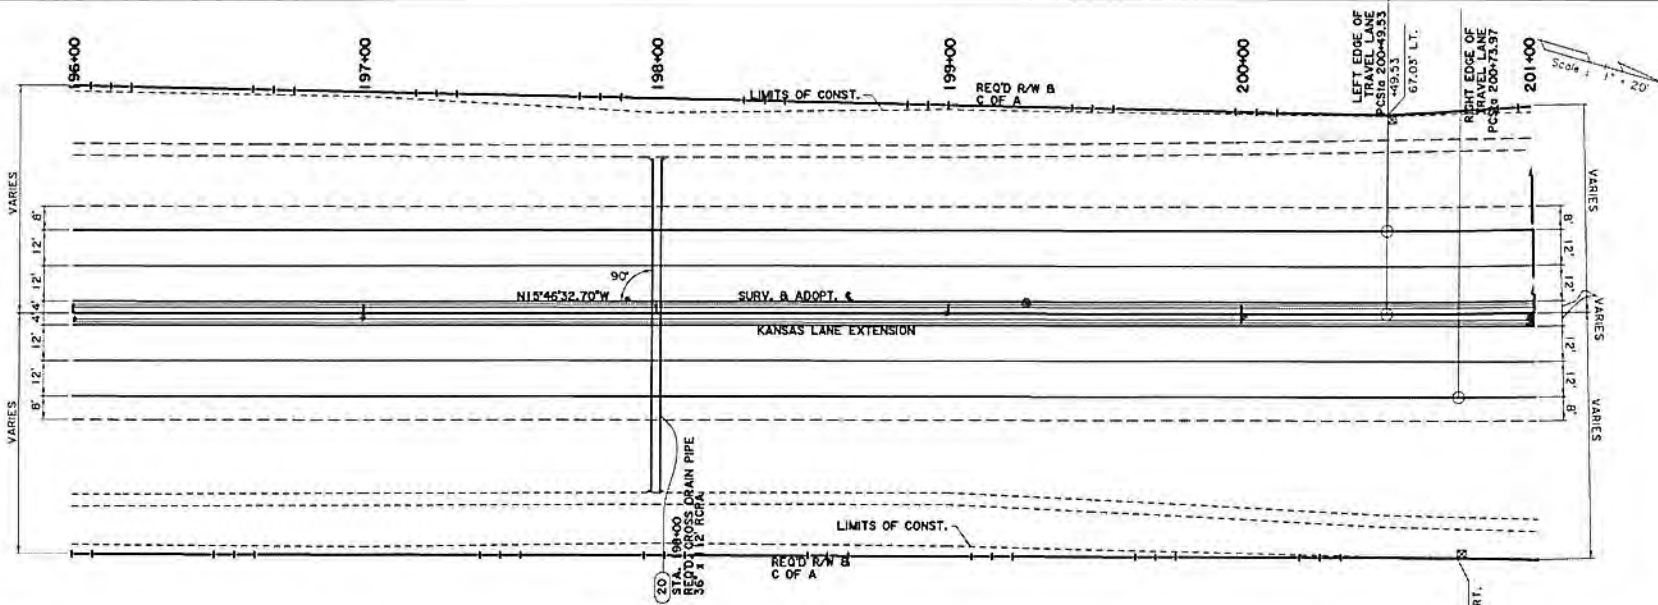


PRELIMINARY
 FOR PERMITTING PURPOSES ONLY
 Louisiana Department of Transportation and Development
 PROJECT: THOMAS ST. OVERPASS
 LICENSE # 19191
 DATE: 2/14/2017

Preliminary Plans
 Subject to Change
Road Design

PROJECT NO.	QUACHITA
DATE	11/16
SCALE	H.007289
DESIGNED BY	
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SCALE	


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PERMIT SKETCHES
 PRELIMINARY
 FOR PERMITTING PURPOSES ONLY
 Louisiana Department of Transportation and Development
 REGISTERED: THOMAS R. BOWEN
 LICENSE # 15162
 DATE: 2/24/07

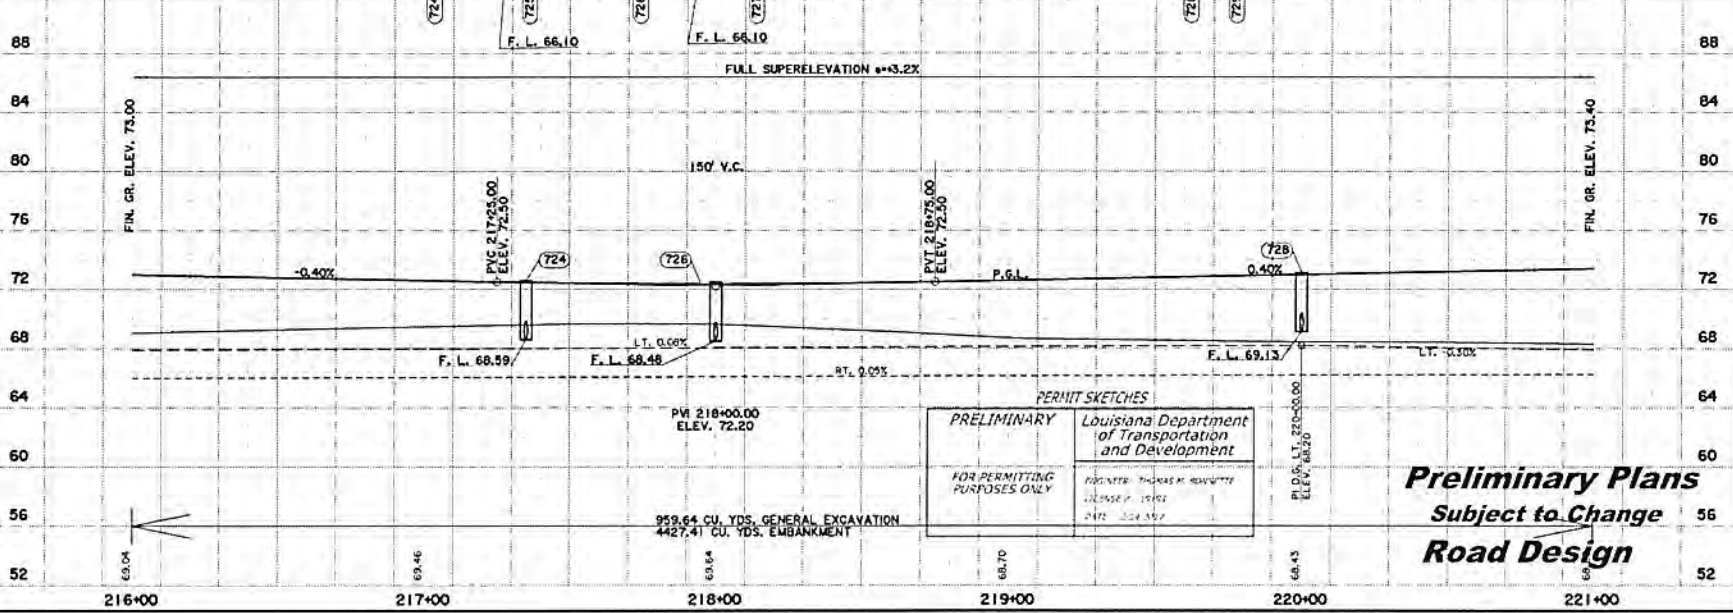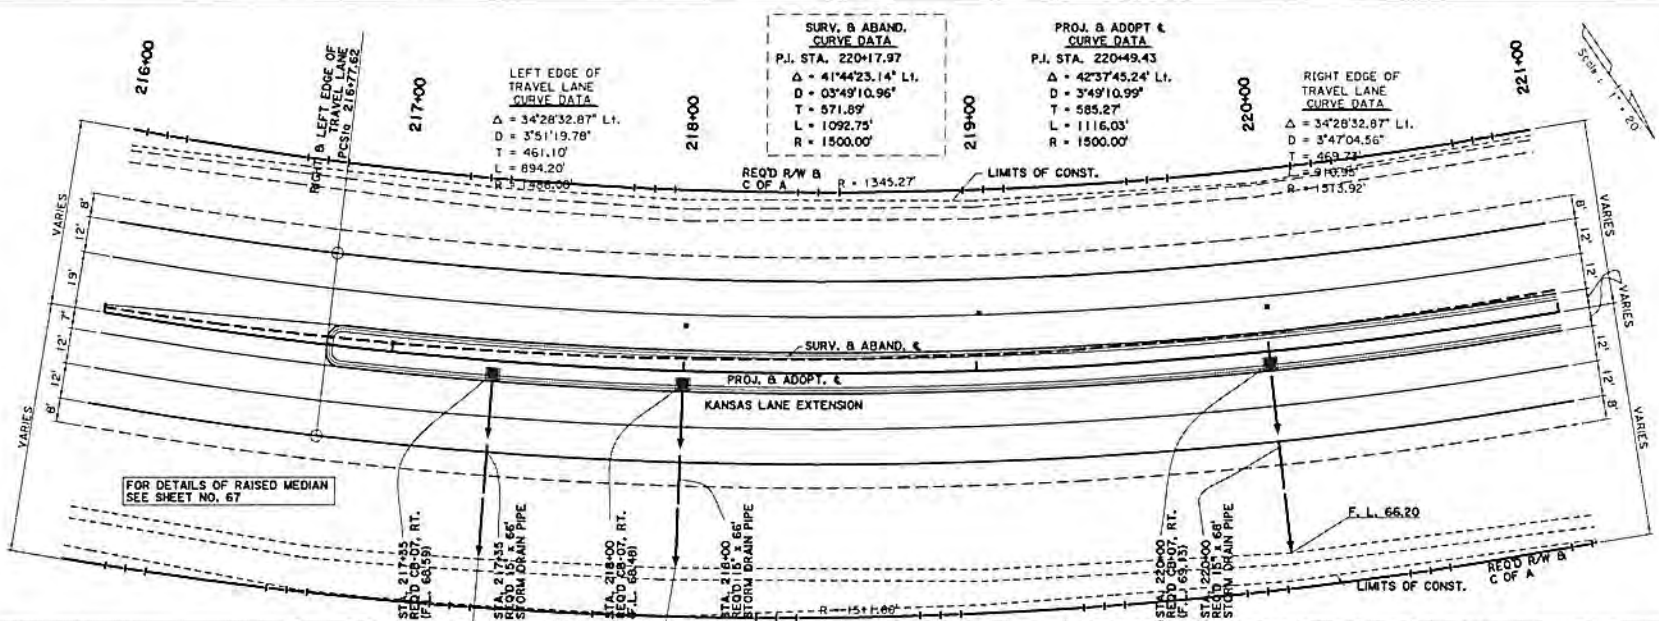
Preliminary Plans
 Subject to Change
Road Design

PROJECT NUMBER	28
DISTRICT	DUACHITA
DESIGNER	BOFA
DATE	1/1/16
PROJECT NAME	KANSAS LANE EXTENSION
PROJECT NUMBER	H.007289



REMOVE EXIST. SURFACING AND STABILIZED BASE
 REMOVE EXIST. CONCRETE

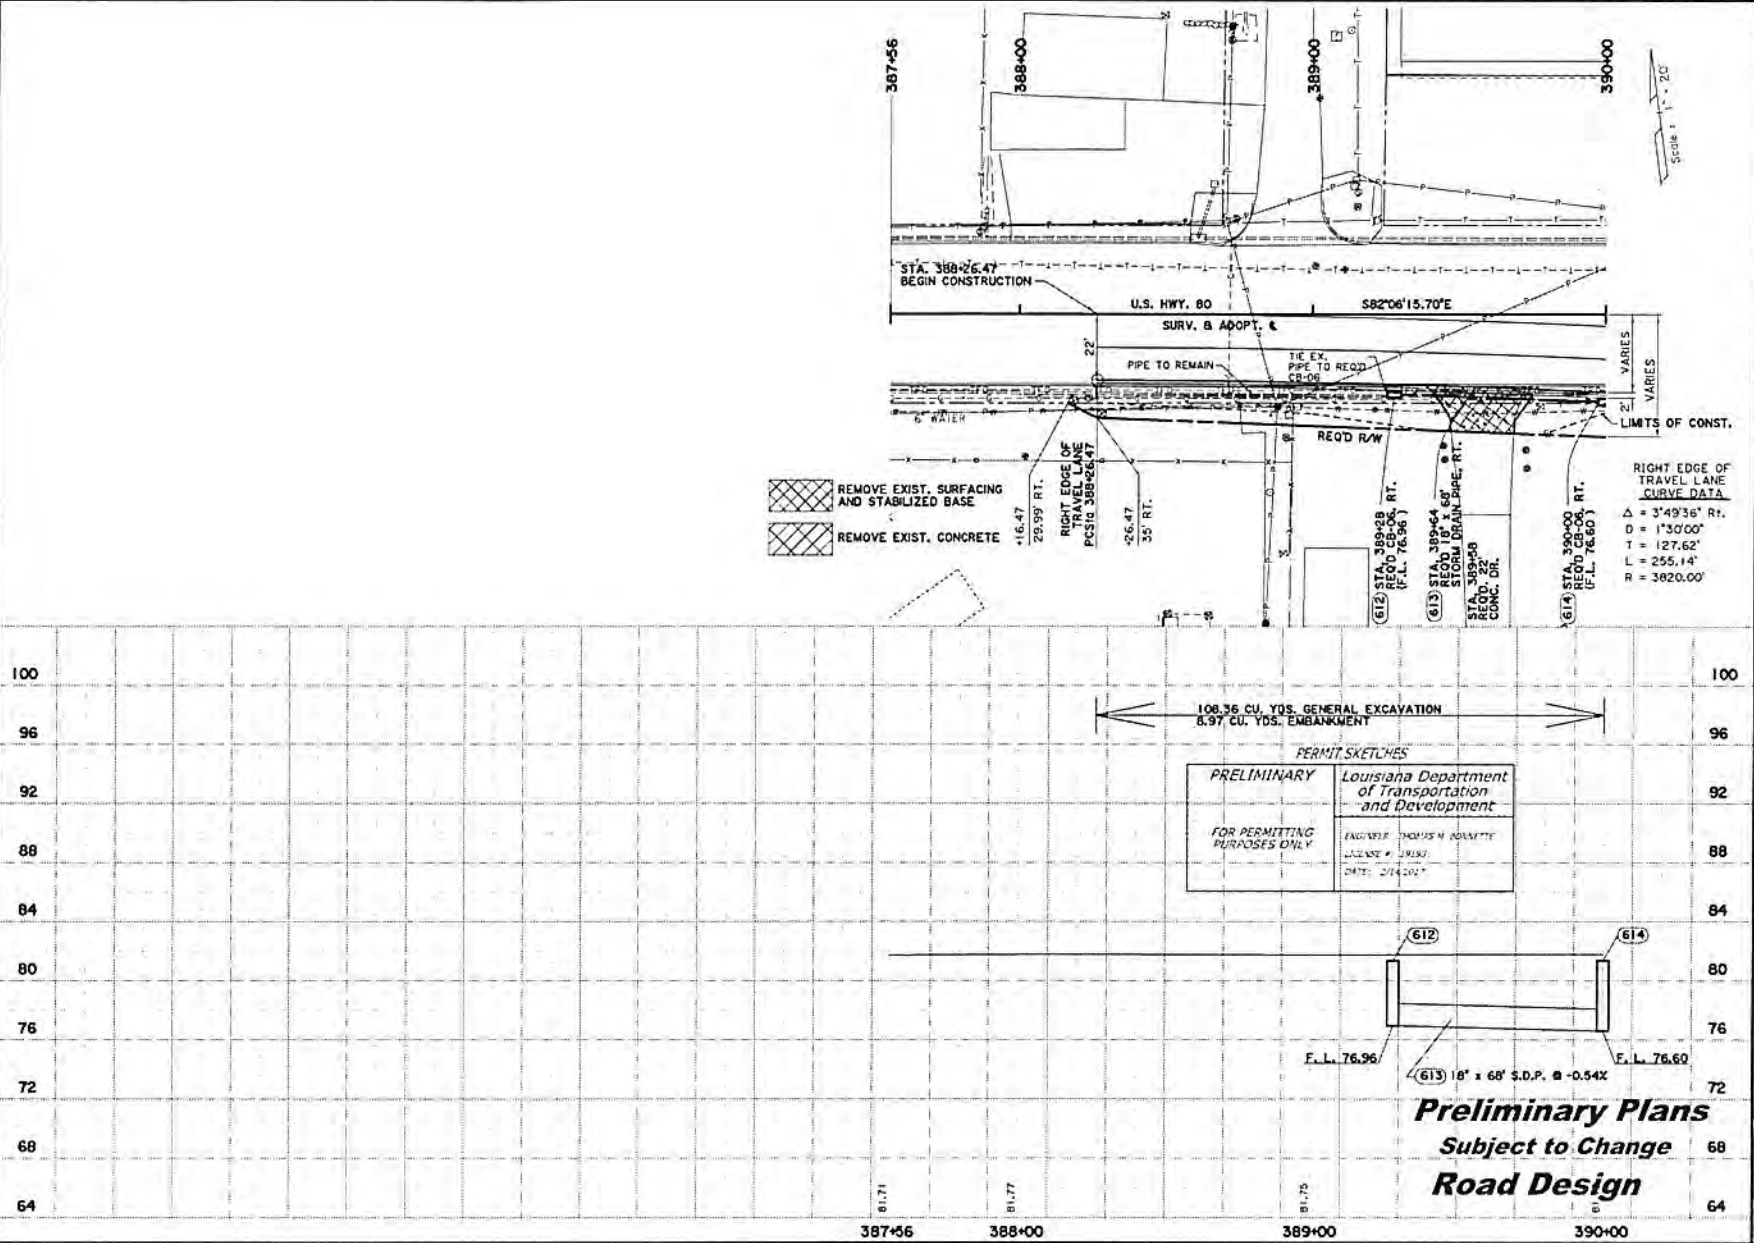
PERMIT SKETCHES
PRELIMINARY Louisiana Department of Transportation and Development
 FOR PERMITTING PURPOSES ONLY
 ENGINEER: THOMAS M. HOLMSTEDT
 LICENSE # 39183
 DATE: 2/14/2017

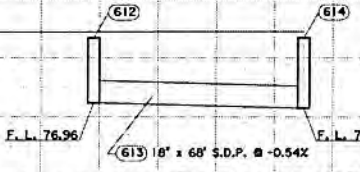

Preliminary Plans
 Subject to Change
Road Design


DATE	BY	SCALE	PROJECT	DRAWING NO.	SHEET NO.
			DUACHITA	H.007289	33

PERMIT SKETCHES

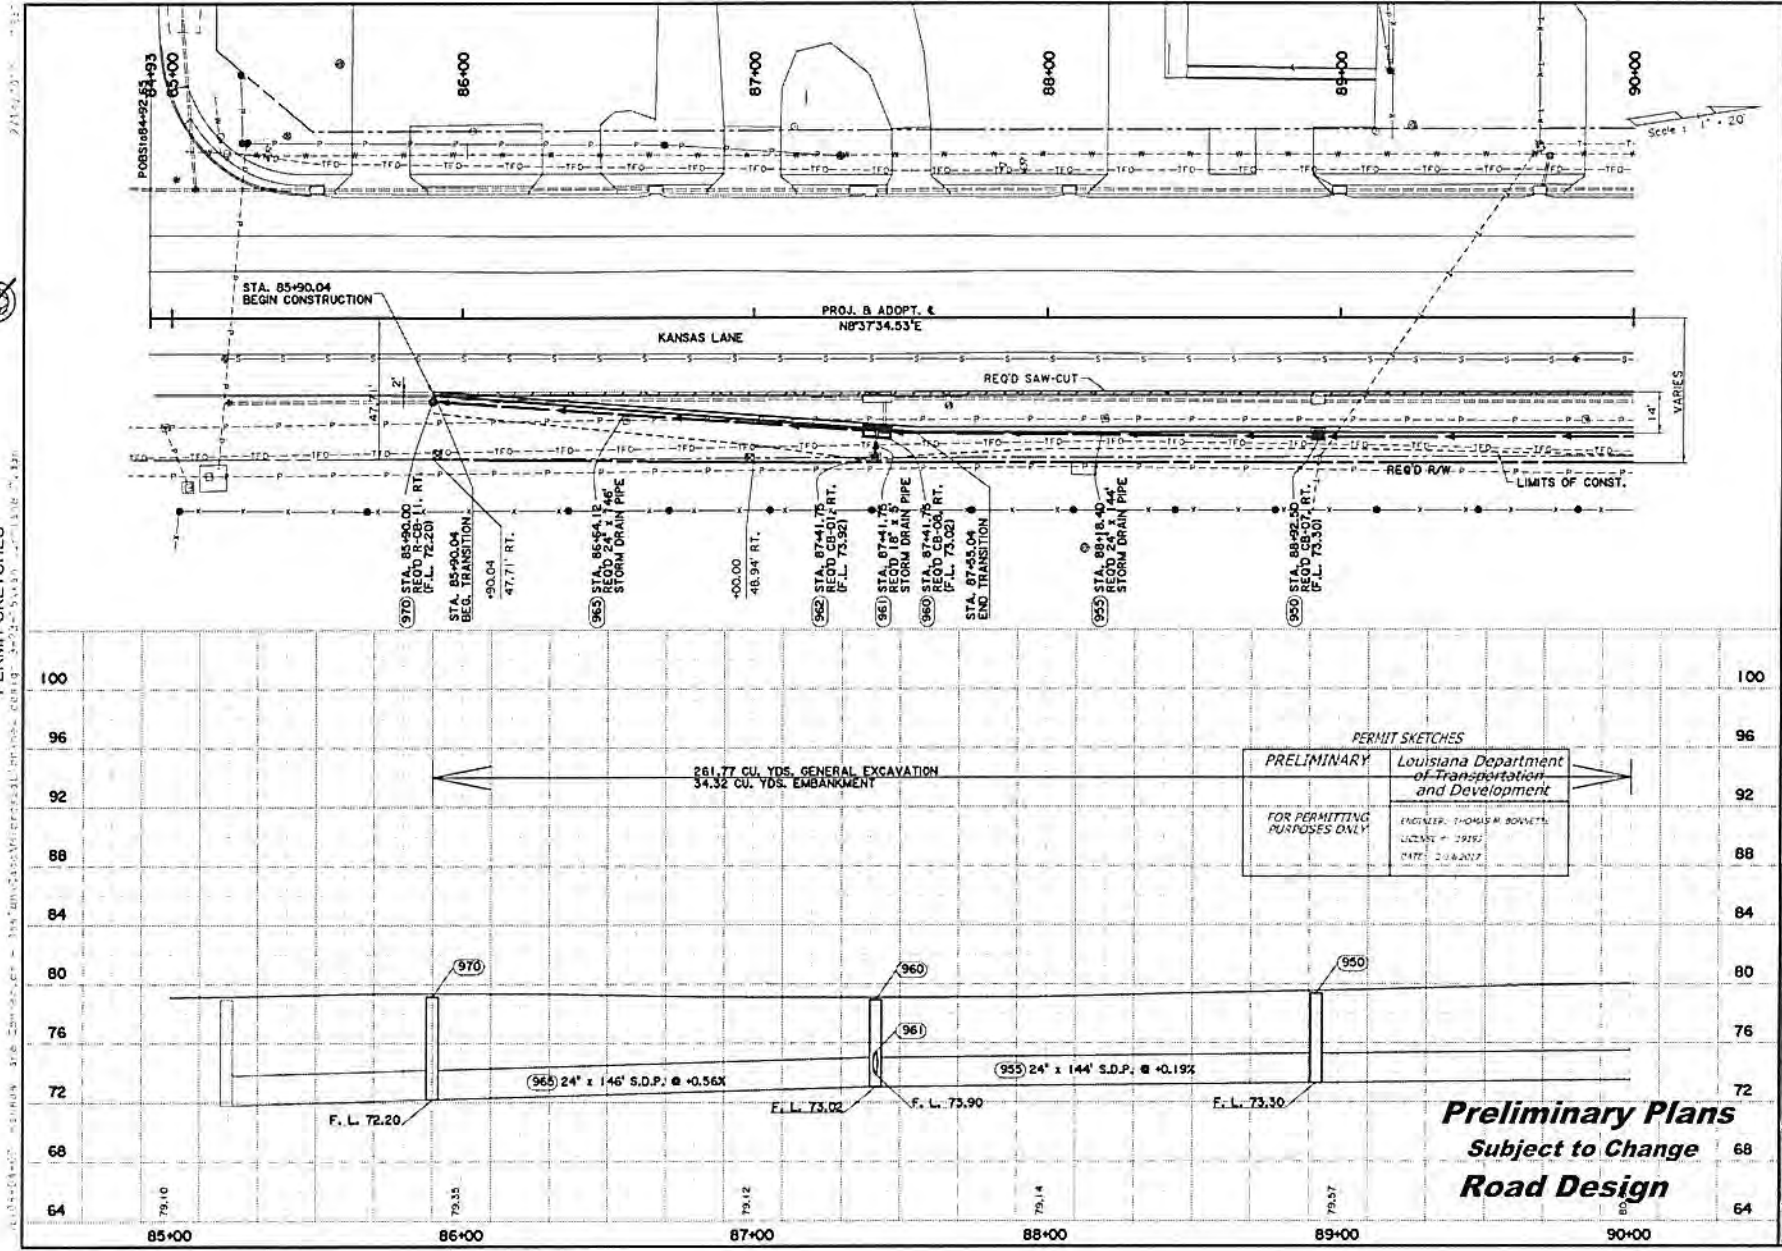

PROJECT NUMBER	441
DATE	11/16
PROJECT	H-007289
DESIGNER	DUACHITA
SCALE	1" = 20'

1:024-01-01 - address 310 Shreveport - 143 AnnDaisyWierstraCantelosa - 3474 - 312204.rvt(1/23/10) 15:21:17
 PERMIT SKETCHES
 PROJECT: BON AIRE DRIVE RIGHT - PLAN AND PROFILE - KANSAS LANE EXTENSION

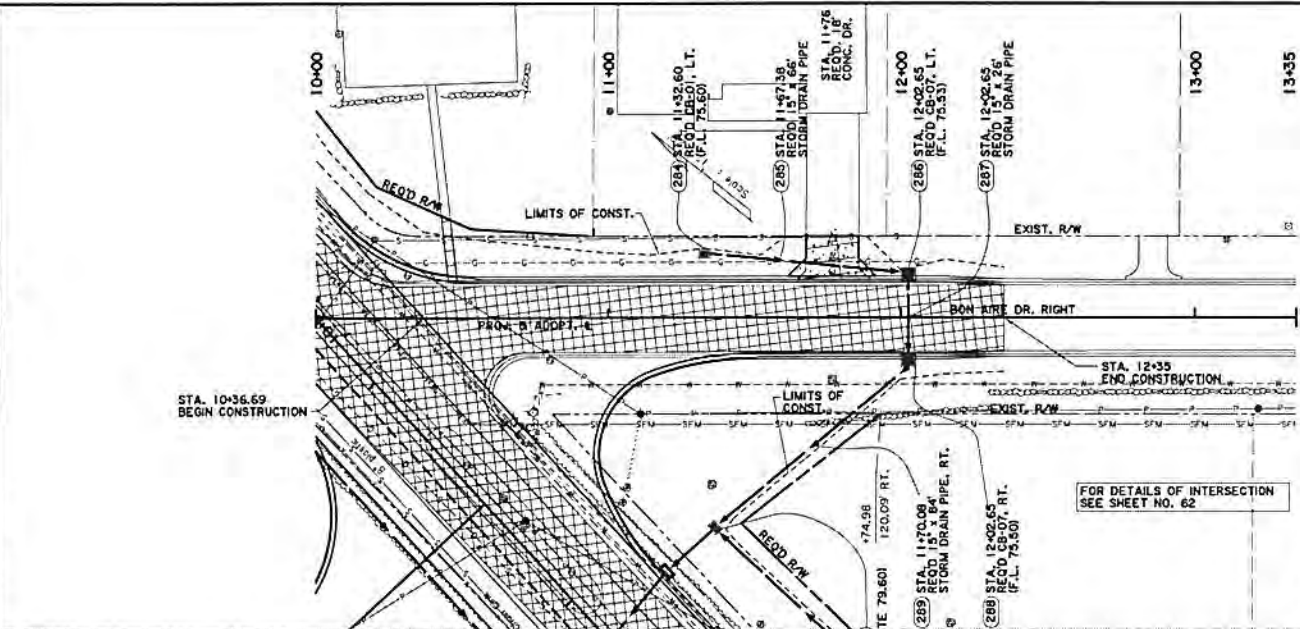


PERMIT SKETCHES

PRELIMINARY Louisiana Department
 of Transportation
 and Development
 FOR PERMITTING
 PURPOSES ONLY

PREPARED BY: THOMAS H. BUNDS/2
 CHECKED BY: JH/AT
 DATE: 2/21/2017

- REMOVE EXIST. SURFACING AND STABILIZED BASE
- REMOVE EXIST. CONCRETE

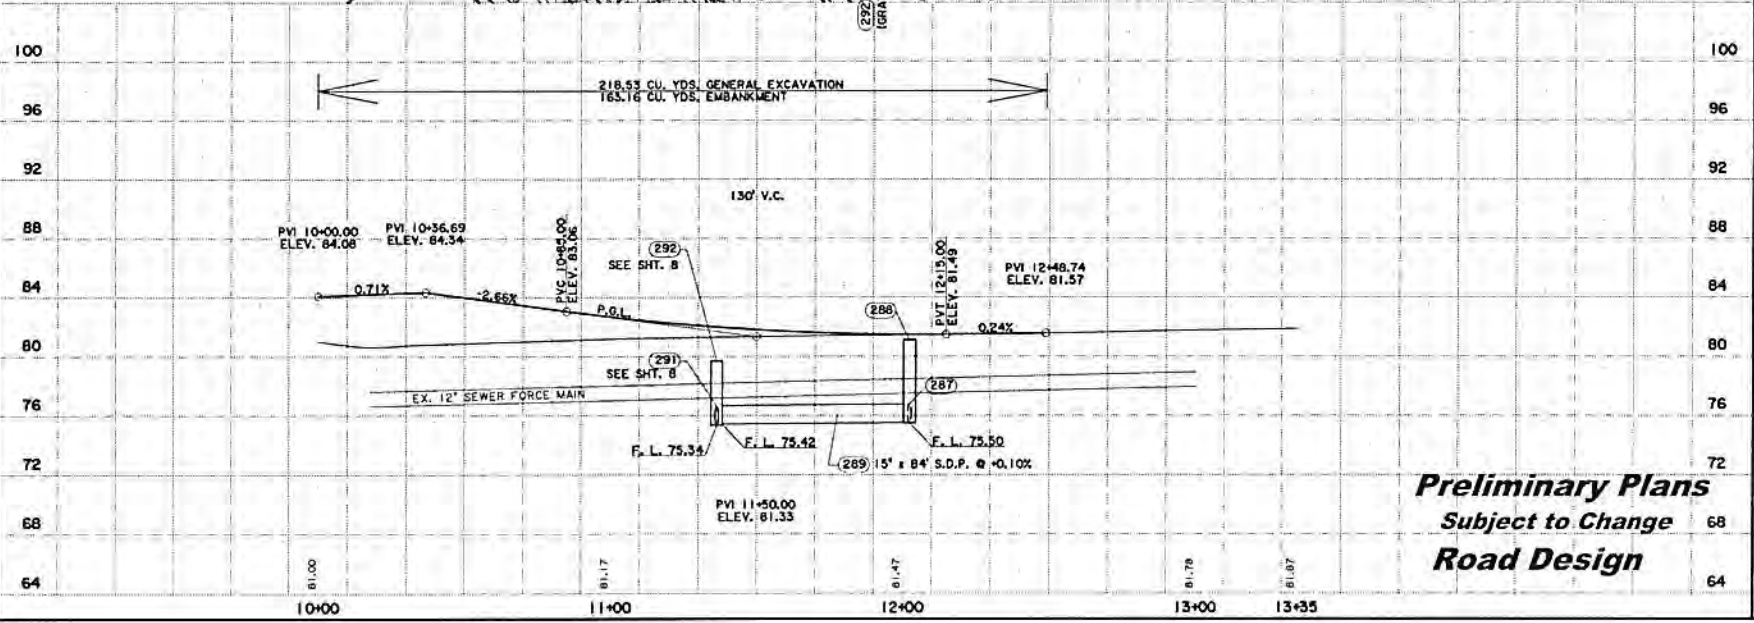

Preliminary Plans
 Subject to Change
Road Design

SHEET NUMBER	46	PROJECT	DUACHITA	DATE	11/7/16
DESIGNED BY	THOMAS H. BUNDS/2	CHECKED BY	JH/AT	DATE	2/21/2017
BON AIRE DRIVE RIGHT PLAN AND PROFILE KANSAS LANE EXTENSION					




PROPOSED STRUCTURE

CONCRETE TYPE 3 GIRDER BRIDGE
 SPANS = 14 @ 50'-0"
 CONCRETE RAILING = STANDARD BARRIER (END SPANS & APPROACH SLAB)
 SLOTTED BARRIER (INTERMEDIATE SPANS)
 DOUBLE FACE MEDIAN BARRIER

ROADWAY = AS SHOWN
 LOADING = LIVE LOAD 15 HL-93 & LADV-11
 DESIGN SPEED = 45 MPH
 ALIGNMENT = AS SHOWN
 SKEW = 90°
 DESIGN YEAR ADT (2030) = 27,300
 ROADWAY CLASSIFICATION = UA-2


NOTE: FILL TO BE IN PLACE AND EXCAVATION TO BE MADE PRIOR TO DRIVING PILES AFFECTED.

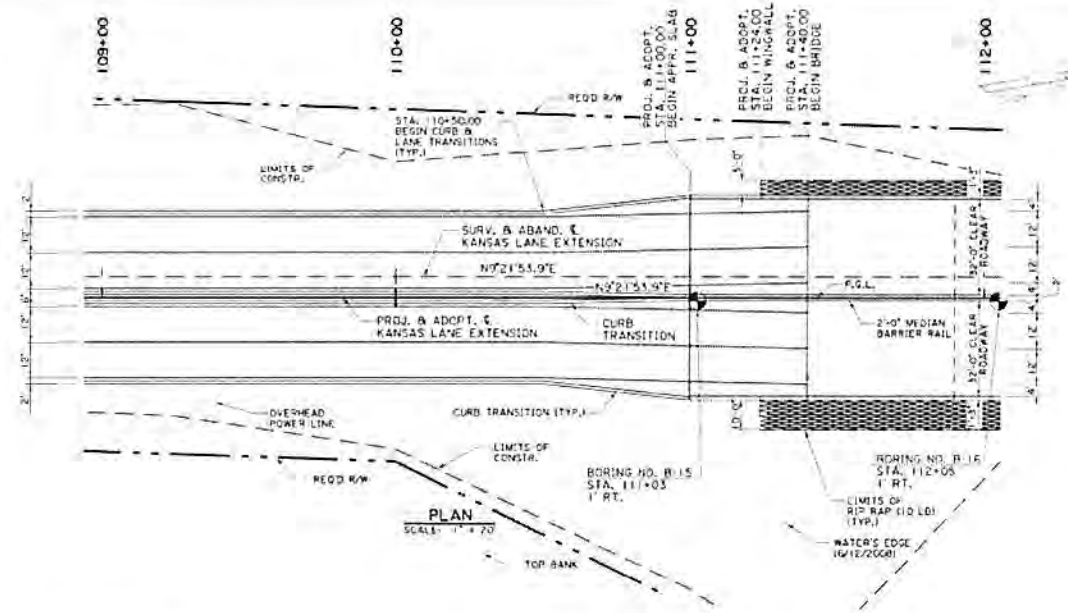

LAZENBY & ASSOCIATES, INC.
 PRELIMINARY - FOR PERMIT PURPOSES ONLY
 These drawings were prepared by or under the supervision of
 Barry C. Spurgeon
 P.E. No. 12924
 Dates Mar., 2017

150' VERTICAL CURVE
 P.V.I., STA. 112+00.00
 ELEV. 86.00
 G1 = 0.42%
 G2 = 0.00%

40'-0" CONC. APPR. SLAB
 700'-0" TOTAL LENGTH OF BRIDGE
 150'-0" 13 - 50' CONT. SPAN UNITS (TYPE II GIRDERS)
 50'-0" 50'-0"

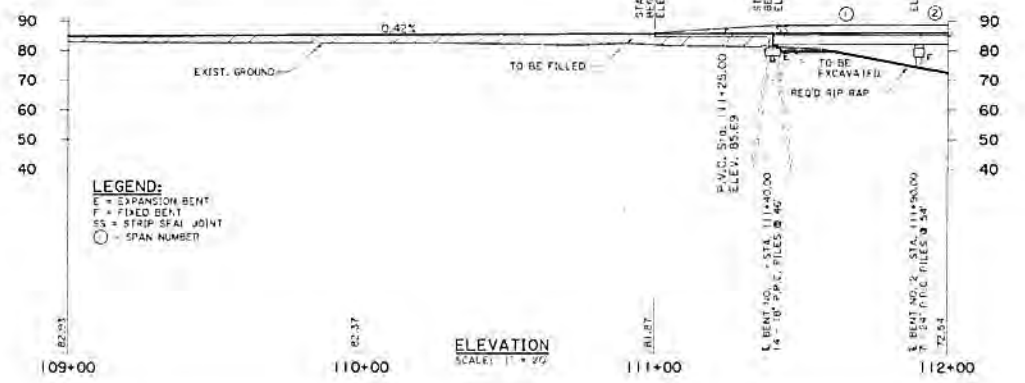

BRIDGE HYDRAULIC DATA

NO HYDRAULIC ANALYSIS WAS REQUIRED FOR THIS BRIDGE SITE DUE TO THE FOLLOWING REASONS:
 BRIDGE IS LOCATED ON BAYOU DESIARD WHERE THE POOL STAGE VARIES FROM ELEVATION 69.00 TO ELEVATION 71.00 PER CITY OF MONROE RECORDS. THIS STAGE IS MAINTAINED BY CONTROL STRUCTURES ALONG THE BAYOU REFERENCED IN THE FLOOD INSURANCE STUDY OF QUACHITA PARISH, LOUISIANA AND INCORPORATED AREAS DATED MARCH 15, 1994. THE EXPECTED FLOW VELOCITIES THROUGHOUT THE BAYOU ARE MINIMAL. THE FINISH GRADE ELEVATION OF THE BRIDGE HAS BEEN ESTABLISHED SUCH THAT THE BRIDGE WILL SPAN FROM HIGH BANK TO HIGH BANK ACROSS THE BAYOU. THE LOW CHORD ELEVATION WILL PROVIDE CLEARANCE FOR RECREATIONAL BOAT TRAFFIC.


203

QUACHITA

GENERAL PLAN
 BAYOU DESIARD BRIDGE
 KANSAS LANE EXTENSION

DOTD
 LAZENBY & ASSOCIATES, INC.

07-944-203 / 15109
 98% FINAL PLANS
 R:\PROJECTS\06013.1 - STATION\As general\06013.dwg

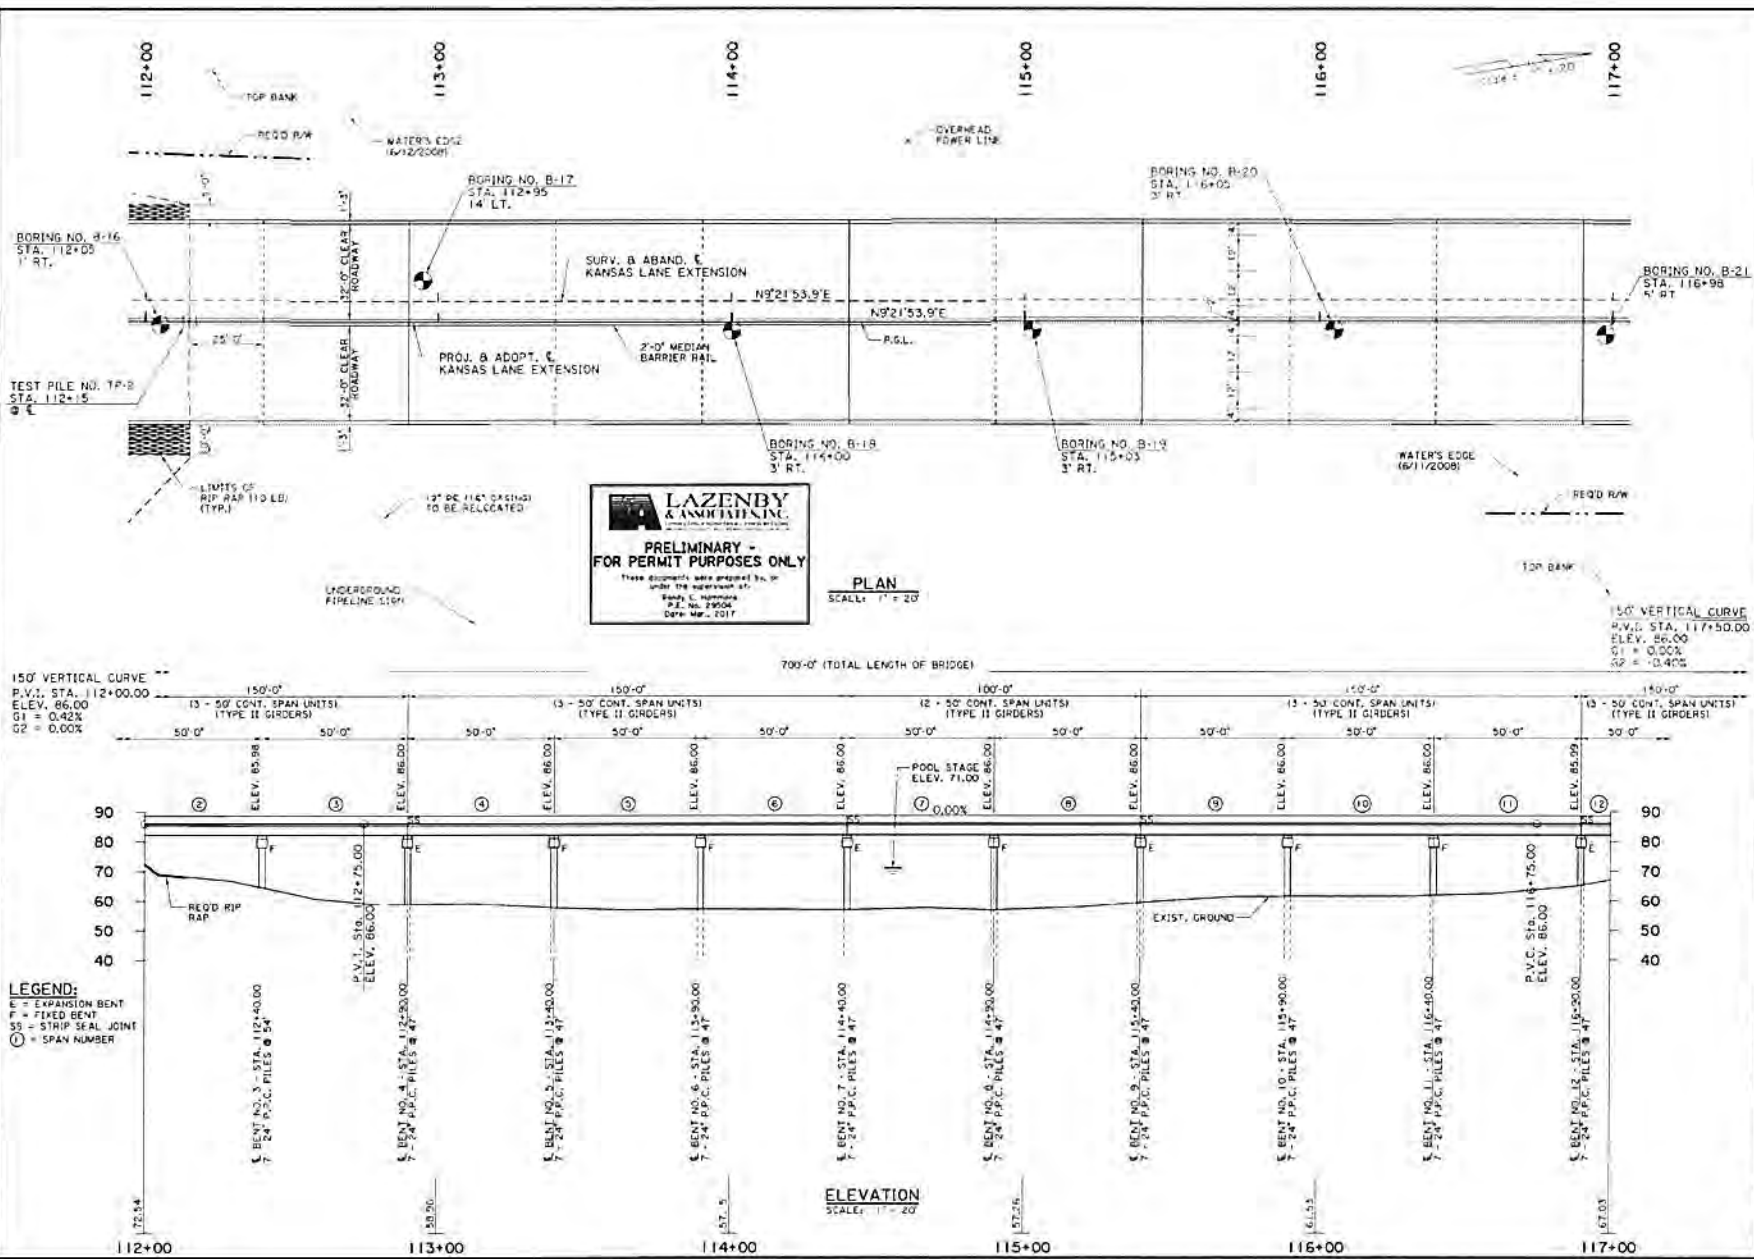


LAZENBY & ASSOCIATES, INC.
 CONSULTING ENGINEERS
 10000 Katy Road, Suite 100
 Houston, Texas 77054
 (713) 861-1100
PRELIMINARY - FOR PERMIT PURPOSES ONLY
 These documents were prepared by us under the supervision of:
 Mark C. Herring
 P.E. No. 79904
 Date: Mar., 2017

DATE	1.24.17	PROJECT	K-007288	SHEET	204
SCALE		CLIENT	QUACHITA	PROJECT NO.	
DESIGNED BY		PROJECT NO.		PROJECT NO.	
CHECKED BY		PROJECT NO.		PROJECT NO.	
APPROVED BY		PROJECT NO.		PROJECT NO.	


GENERAL PLAN
BAYOU DESIARD BRIDGE
KANSAS LANE EXTENSION



98% FINAL PLANS

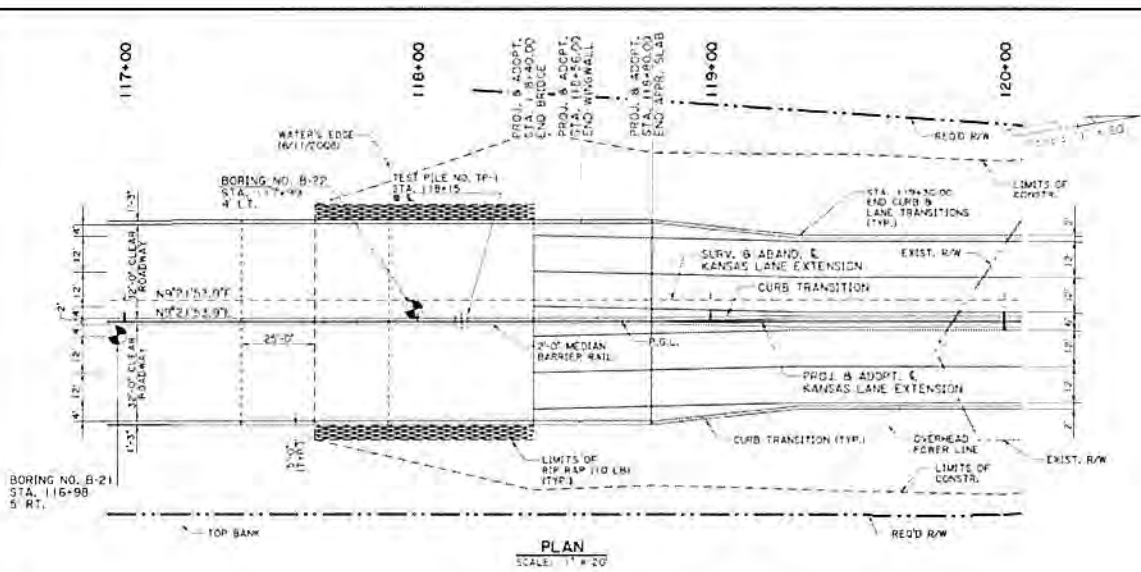

PLAN SCALE: 1" = 20'

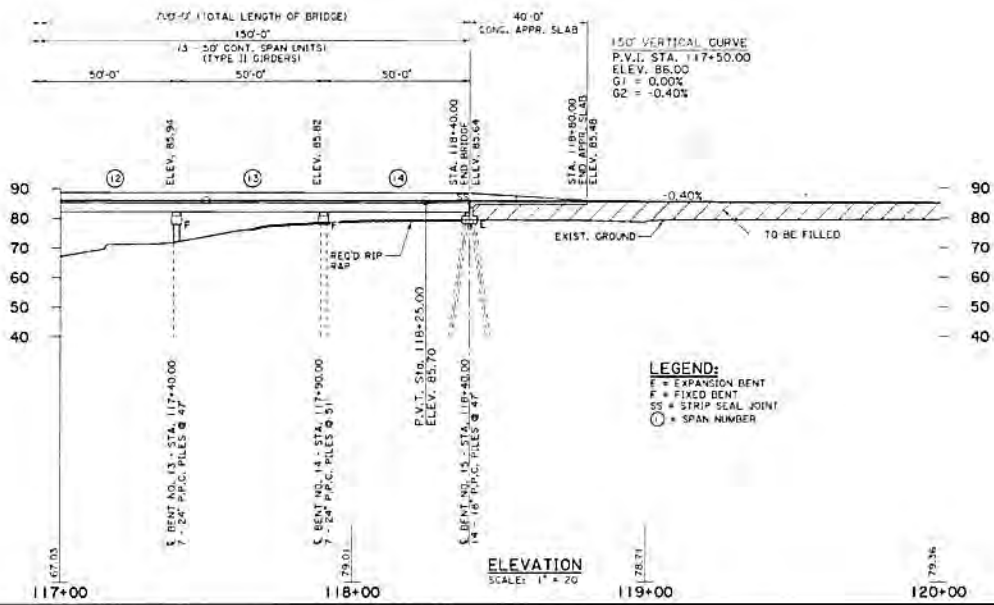

ELEVATION SCALE: 1" = 20'

LAZENBY & ASSOCIATES, INC.
 PRELIMINARY FOR PERMIT PURPOSES ONLY
 These documents were prepared by, or under the supervision of,
 Randy C. Hammond
 P.E. No. 27004
 Date: Mar., 2017


ROLL LABEL	205
PROJECT	4-C07289
DATE	3-05-17
SCALE	AS SHOWN
DESIGNED BY	QUACHITA
CHECKED BY	
IN CHARGE	
APPROVED BY	
PROJECT	KANSAS LINE EXTENSION
DATE	
SCALE	
PROJECT	BAYOU DESJARD BRIDGE
DATE	
SCALE	
PROJECT	KANSAS LINE EXTENSION
DATE	
SCALE	

98% FINAL PLANS
 01/28/07 14411



98% FINAL PLANS

01/28/07 14411 01/28/07 14411

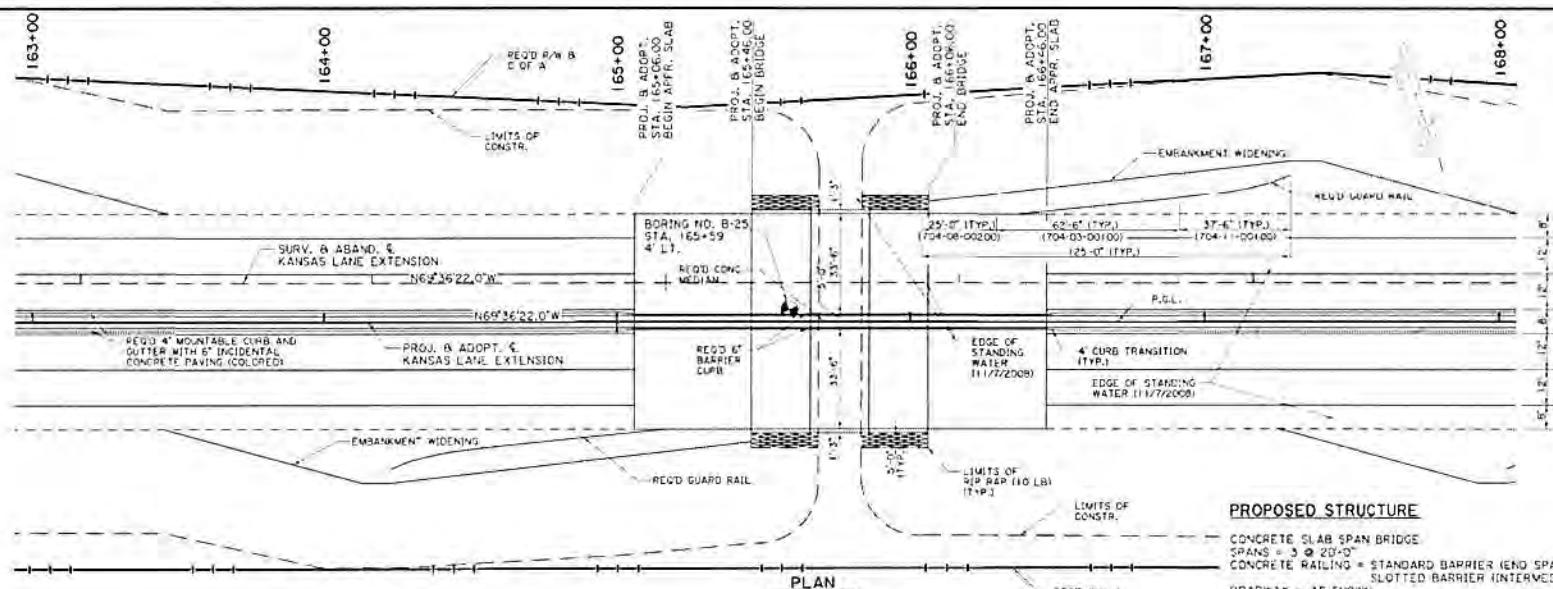


GUARD RAIL DESIGN STANDARDS

HWY. DES. CLASS	DESIGN SPEED	ADT	LC
UA-2	45 M.P.H.	27,300	28'

GUARD RAIL LENGTH REQUIREMENTS

BR. SIDE	LR	LH	Z	L2	A/B	X	Y
LEFT	260'	2H	26.13'	8'	10'	112.50'	15.00'
RIGHT	260'	2B	26.13'	8'	10'	112.50'	15.00'

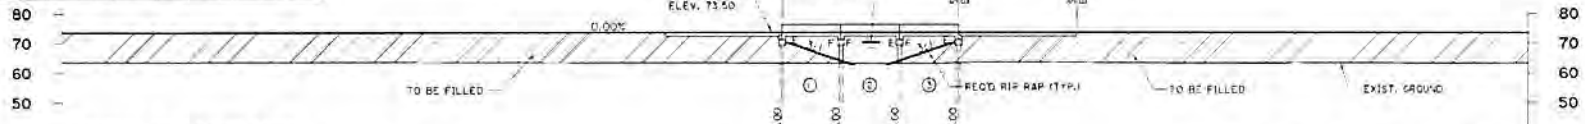

BRIDGE HYDRAULIC DATA

NO HYDRAULIC ANALYSIS WAS REQUIRED FOR THIS BRIDGE SITE DUE TO THE FOLLOWING REASONS:
 BRIDGE IS LOCATED IN A WETLAND AREA AND FUNCTIONS AS A WILDLIFE CROSSING DURING TIMES OF LOW WATER AND AS AN EQUALIZER DURING TIMES OF HIGH WATER. THE 50 YEAR FLOOD ELEVATION IS 70.25 AND THE 100-YEAR FLOOD ELEVATION IS 70.86 BASED ON THE FLOOD INSURANCE STUDY OF QUACHITA PARISH, LOUISIANA AND INCORPORATED AREAS DATED MARCH 15, 1994. THE FINISH GRADE ELEVATION OF THE BRIDGE HAS BEEN ESTABLISHED SUCH THAT THE MINIMUM LOW CHORD ELEVATION WILL BE THE DESIGN WATER SURFACE ELEVATION (50-YEAR). THE REQUIRED BRIDGE LENGTH HAS BEEN ESTABLISHED USING THE FINISH GRADE ELEVATION, THE GEOMETRY OF THE CHANNEL AND 3:1 ABUTMENT SLOPES, AND ALSO SUCH THAT THE MINIMUM CLEAR DISTANCE BETWEEN THE ABUTMENT SLOPES IS APPROXIMATELY 20'.

LEGEND:
 E = EXPANSION BENT
 F = FIXED BENT
 S = SPAN NUMBER


LAZENBY & ASSOCIATES, INC.
 PRELIMINARY - FOR PERMIT PURPOSES ONLY
 Three documents were prepared by or under the supervision of:
 Randy C. Hampton
 P.E., No. 27046
 Civil, No. 2517

01/28/07 14411

QUACHITA

GENERAL PLAN
 CHAUVIN BRIDGE SITE 2
 KANSAS LANE EXTENSION

LAZENBY & ASSOCIATES, INC.

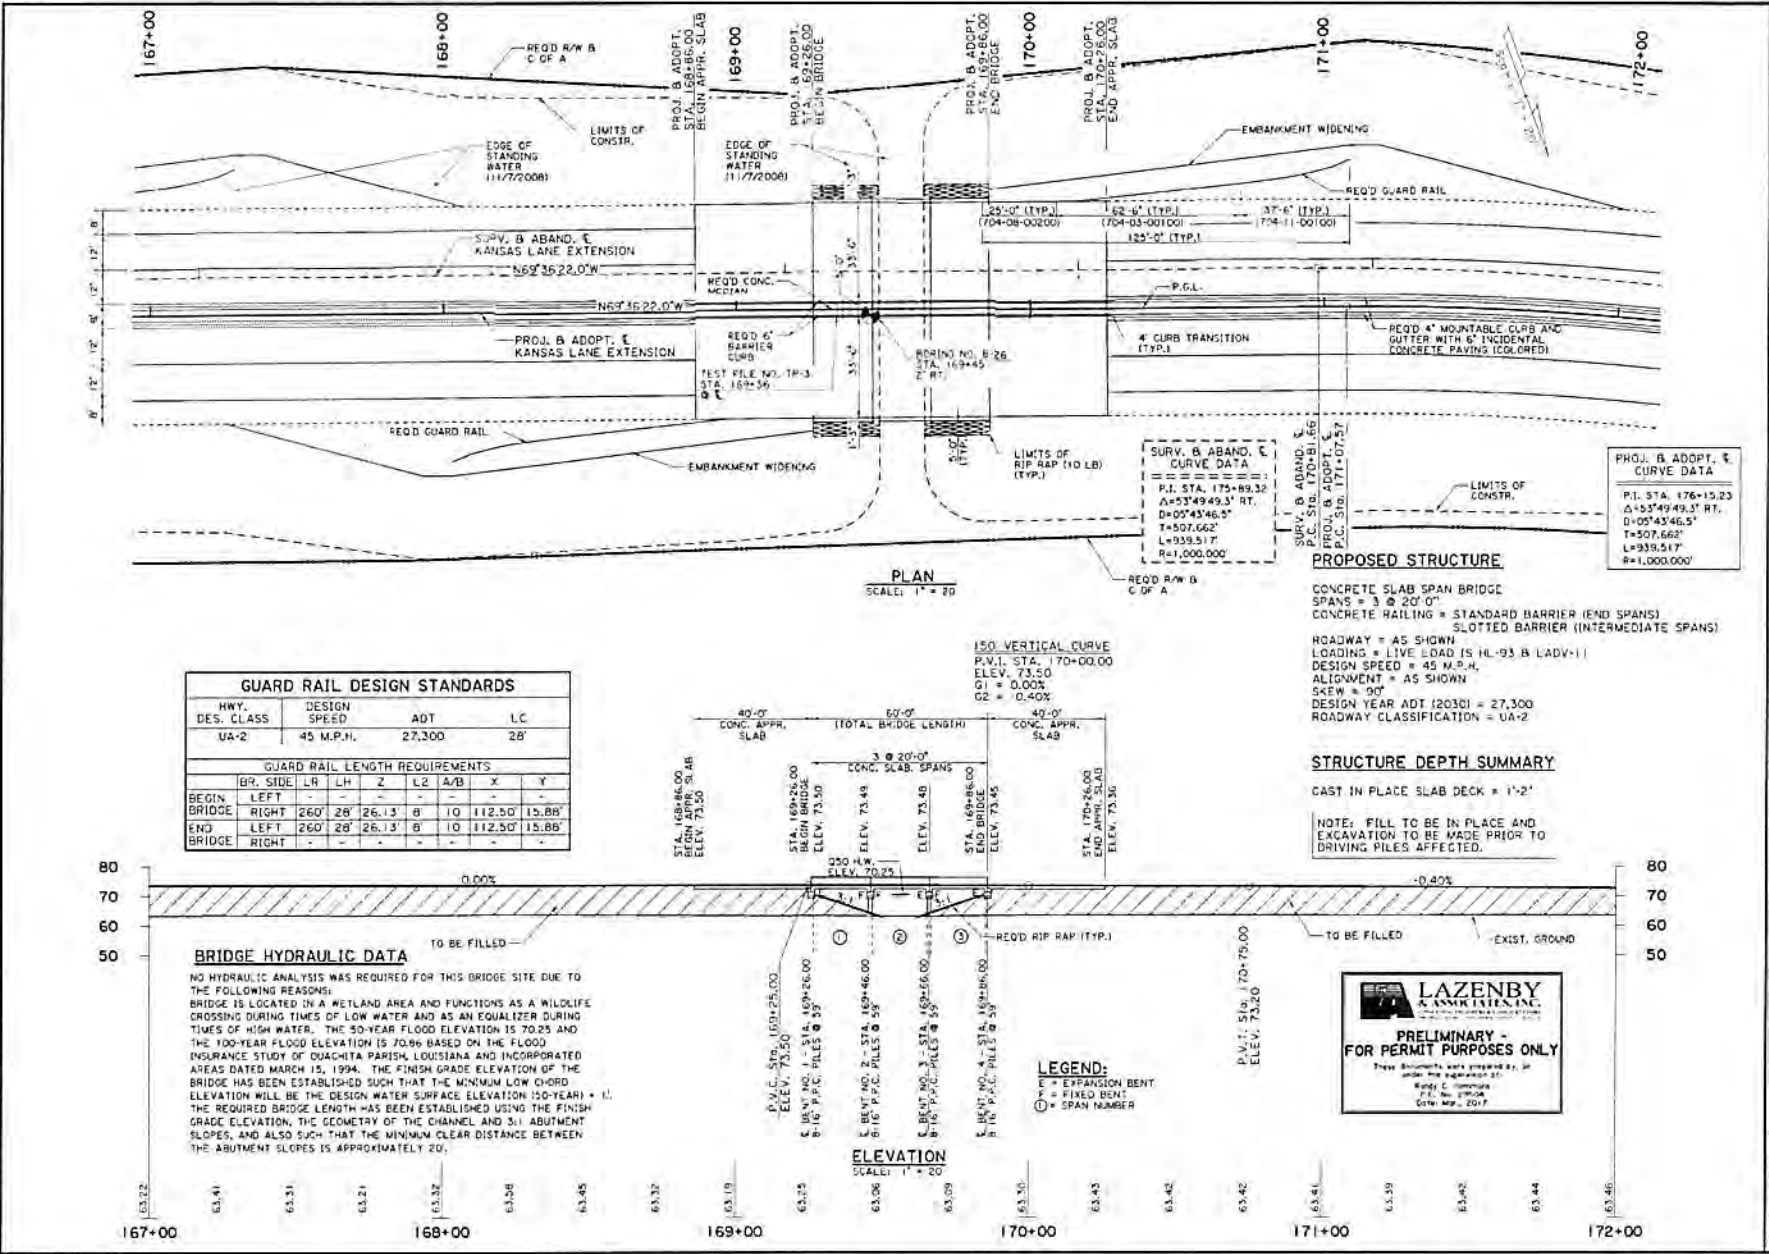

GUARD RAIL DESIGN STANDARDS

HWY. DES. CLASS	DESIGN SPEED	ADT	LC
UA-2	45 M.P.H.	27,300	28'

GUARD RAIL LENGTH REQUIREMENTS

BR. SIDE	LR	LH	Z	L2	A/B	X	Y
LEFT	260'	28'	26.13'	0'	10'	112.50'	15.88'
RIGHT	260'	28'	26.13'	0'	10'	112.50'	15.88'

BRIDGE HYDRAULIC DATA

NO HYDRAULIC ANALYSIS WAS REQUIRED FOR THIS BRIDGE SITE DUE TO THE FOLLOWING REASONS:
 BRIDGE IS LOCATED IN A WETLAND AREA AND FUNCTIONS AS A WILDLIFE CROSSING DURING TIMES OF LOW WATER AND AS AN EQUALIZER DURING TIMES OF HIGH WATER. THE 50-YEAR FLOOD ELEVATION IS 70.25 AND THE 100-YEAR FLOOD ELEVATION IS 70.99 BASED ON THE FLOOD INSURANCE STUDY OF QUACHITA PARISH, LOUISIANA AND INCORPORATED AREAS DATED MARCH 15, 1994. THE FINISH GRADE ELEVATION OF THE BRIDGE HAS BEEN ESTABLISHED SUCH THAT THE MINIMUM LOW Q-ORD ELEVATION WILL BE THE DESIGN WATER SURFACE ELEVATION (50-YEAR) + 1'. THE REQUIRED BRIDGE LENGTH HAS BEEN ESTABLISHED USING THE FINISH GRADE ELEVATION, THE GEOMETRY OF THE CHANNEL AND 3:1 ABUTMENT SLOPES, AND ALSO SUCH THAT THE MINIMUM CLEAR DISTANCE BETWEEN THE ABUTMENT SLOPES IS APPROXIMATELY 20'.

PROPOSED STRUCTURE

CONCRETE SLAB SPAN BRIDGE
 SPANS = 3 @ 20' 0"
 CONCRETE RAILING = STANDARD BARRIER (END SPANS) SLOTTED BARRIER (INTERMEDIATE SPANS)

ROADWAY = AS SHOWN
 LOADING = LIVE LOAD [S HL-93 & LADV-1]
 DESIGN SPEED = 45 M.P.H.
 ALIGNMENT = AS SHOWN
 SCAW = 90'
 DESIGN YEAR ADT (2033) = 27,300
 ROADWAY CLASSIFICATION = UA-2

STRUCTURE DEPTH SUMMARY

CAST IN PLACE SLAB DECK = 1'-2"

NOTE: FILL TO BE IN PLACE AND EXCAVATION TO BE MADE PRIOR TO DRIVING PILES AFFECTED.

PROJECT NO.	208
DATE	11-06-2016
PROJECT NAME	QUACHITA
LOCATION	LAZEXBY & ASSOCIATES, INC.
SCALE	1" = 40'
DATE	11-06-2016
PROJECT NO.	208
DATE	11-06-2016
PROJECT NAME	QUACHITA
LOCATION	LAZEXBY & ASSOCIATES, INC.
SCALE	1" = 40'
DATE	11-06-2016

GENERAL PLAN CHAUVIN BRIDGE SITE 3

LAZEXBY & ASSOCIATES, INC.